

Notice is hereby given according to State Statutes that the SITE REVIEW COMMITTEE of the Village of Hobart will meet on Wednesday February 23rd 2022 at 5:30 P.M. at the Hobart Village Office. NOTICE OF POSTING: Posted this 18th day of February, 2022 at the Hobart Village Office, 2990 S. Pine Tree Rd and on the village's website.

MEETING NOTICE - SITE REVIEW COMMITTEE

Date/Time: Wednesday February 23rd 2022 (5:30 P.M.) Location: Village Office, 2990 South Pine Tree Road

ROUTINE ITEMS TO BE ACTED UPON:

1. Call to order/Roll Call.

- 2. Certification of the open meeting law agenda requirements and approval of the agenda.
- 3. Approve Minutes of the December 21st 2021 meeting (Page 2)
- 4. Public Comment on Non-Agenda Items

ACTION ITEMS

5. DISCUSSION AND ACTION – Request for New Wall Signage - 550 Centennial Centre Blvd., HB-3208; Wall Signage, Scott's Subs (Page 3)

Scott's Subs, located at 550 Centennial Centre Blvd., is currently under construction and is submitting for review and approval of the proposed wall signs. During the original site review back in October 2021, the wall signage locations were identified, however, the sign details were not known at that time. The developer has since finalized the signage and is requesting review of the proposed wall signage.

6. DISCUSSION AND ACTION - New 3,697 square foot commercial building and associated site improvements - 565 Larsen Orchard Parkway, HB-3206 (Page 9)

This property located along Larsen Orchard Parkway is currently undeveloped, and the proposed project will consist of a new 3,697 square foot, single story, business/dental clinic.

7. ADJOURN

Aaron Kramer – Village Administrator

Members: Dave Dillenburg (Chairperson), Debbie Schumacher, Dave Baranczyk, Rick Nuetzel, Tom Tengowski, Peter Zobro, Steve Riley

NOTE: Page numbers refer to the meeting packet. All agenda and minutes of Village meetings are online: <u>www.hobart-wi.org</u>. Any person wishing to attend, who, because of disability requires special accommodations, should contact the Village Clerk-Treasurer at 920-869-1011 with as much advanced notice as possible. Notice is hereby given that action by the Committee may be considered and taken on any of the items described or listed in this agenda. There may be Committee members attending this meeting by telephone if necessary.



Village of Hobart Site Review Committee Minutes Hobart Village Office; 2990 S. Pine Tree Rd, Hobart, WI Tuesday, December 21, 2021 – 5:30 pm

1. Call to Order, Roll Call:

The meeting was called to order by Dave Dillenburg at 5:31pm. Roll call: Dave Dillenburg, aye; Debbie Schumacher, aye; Steve Riley, aye; Dave Baranczyk, aye; Peter Zobro, excused; Rick Nuetzel, aye; Tom Tengowski, excused.

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2. Verify/Modify/Approve Agenda:

Motion by Rick Nuetzel, second by Debbie Schumacher, to approve the agenda as presented with the amendment of item 3 to exchange 'November' with 'October'. The motion passed unanimously.

3. Approval of Site Review Minutes:

Motion by Dave Dillenburg, second by Dave Baranczyk, to approve the October 20, 2021 minutes as presented. The motion passed unanimously.

4. Public Comment on Non-Agenda Items: None.

5. Proposed Freestanding Development Signs at 720 Centerline Drive (HB-523-6):

Motion by Debbie Schumacher, second by Rick Nuetzel, to approve the temporary freestanding development signs as submitted subject to the following conditions:

- 1. Signs shall maintain a minimum of 10 feet from property lines;
- 2. Overall sign height shall not exceed 12 feet from grade.

The motion passed unanimously.

6. Update – Modifications to Article XIII PDD #1: Centennial Centre at Hobart District of the Zoning Code:

Director of Planning & Code Compliance updated the committee on the height requirement changes to the PDD #1: Centennial Centre section of the zoning code that were passed by the Planning and Zoning Commission and the Village Board.

7. Adjourn:

Motion by Dave Dillenburg, second by Rick Nuetzel, to adjourn. The motion passed unanimously. Meeting adjourned at 5:49pm.



TO: Site Review Committee RE: 550 Centennial Centre Blvd., HB-3208; Wall Signage, Scott's Subs

FROM: Todd Gerbers, Director of Planning and Code Compliance

DATE: February 23, 2022

ISSUE: Discussion and action on a request for new wall signage

RECOMMENDATION: Staff recommends approval subject to any conditions the Committee may identify.

GENERAL INFORMATION

- 1. Developer: Scott's Subs
- 2. Applicant: Heather Leonard and Creative Sign Co.
- 3. Address/Parcel: 550 Centennial Centre Blvd. / HB-3208
- 4. Zoning: PDD #1: Centennial Centre at Hobart District
- 5. Use: Business / Restaurant

BACKGROUND

Scott's Subs, located at 550 Centennial Centre Blvd., is currently under construction and is submitting for review and approval of the proposed wall signs. During the original site review back in October 2021, the wall signage locations were identified, however, the sign details were not known at that time. The developer has since finalized the signage and is requesting review of the proposed wall signage.


The approved plans back in October 2021 had signs proposed on three sides of the building and although this request is only for two of those same building elevations (south and west), Staff recommends including either of these two sign layouts to be possibly mounted on the east elevation as well. The request before the Committee at this time would be for a sign logo and channel letters of a total of 28.87 square feet on the south elevation (facing Centennial Centre Blvd.) and a logo only of 14.44 square feet on the west elevation (facing round-a-bout). All proposed signs are code compliant and will be internally illuminated with LED lighting. Per ordinance, 10% of the wall surface of each building elevation can be covered by signage so both wall signs would be in compliance with the Village Sign Code.

RECOMMENDATION/CONDITIONS

Staff recommends approval of the proposed 28.87 square foot wall sign to be mounted on the south elevation of the building, a 14.44 square foot wall sign to be mounted on the west elevation of the building as submitted and up to a maximum of 28.87 square foot wall sign on the east elevation of the building.


1	PAGE 4				
	HOBART GREATNESS IS GROWING		lding Permit Ap rmit Number (Assigned by Village Perso		Village of Hobart Dept of Neighborhood Services 2990 S Pine Tree Rd Hobart WI 54155 Phone: (920) 869-3809 Fax (920) 869-2048
	Project Address 550 Cent Applicant is the: Owner Use Category: Single Family D	<u>CANÌA</u> OR Duplex □M	L Centre Contractor ulti-Family Commen	Parcel Numbe	
-	Owner's Name: Heather Leonard 565 Sun lite DE e-mail: Hobart, WI 54155 Hieonard 325600	mail.co	Mailing Address:		Tel: 920-668-7822 Fax: Mobile: Same
Sign	Building Contractor Name: Creating Sign Co. Frail: Sanice @ creative sign company.	Lic# Qualifier#	Mailing Address: 505 Lawre De Pere, WI	54115	Tel: 920 - 336-8900 Fax: Mobile: 920 - 660-0054
	Electrical Contractor Name:	Lic#	Mailing Address:		Tel: Fax: Mobile:
	HVAC Contractor Name: e-mail:	Lic#	Mailing Address:		Tel: Fax: Mobile:
	Plumbing Contractor Name:	Lic#	Mailing Address:		Tel: Fax: Mobile:
	Work being done: New Structure Addition External Remodeling Internal Remodeling Hot Tub/Spa Fence/Kennel Swimming Pool Wrecking Perm Additional information, such	it 1 as plan sul	Deck/Porch/P Garage/Utility Sign/Canopy/ Other bmittal and approval, r	Awning I	□ Driveway/Parking □ Handicap Ramp □ Stove/Fireplace efore issuance.
	Scope of work: FABRICATE	" Jasi aters ases	HALL'I LED Set ON 57 <u>Elevent</u> r d in this application is	South 2	- lit BUILDING
	Total Value of Project \$ 6760.	2 P. 2			consistency in assessing permit fees.)
	Breakdown of values: Bldg Elec		Plumb	HV	AC
	I certify the above information is complete and accurate.				
	Applicant Name: <u>Heather Leona</u> (Please print) Signature: <u>AllMa</u> Leona	10 [S	cottsSubs		
	Date: <u>X-11-X</u> Copy to: Property File Applicant Assessor Inspector Permit File	Total Fo	ees Collected:	Branch and a second	Check #

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1

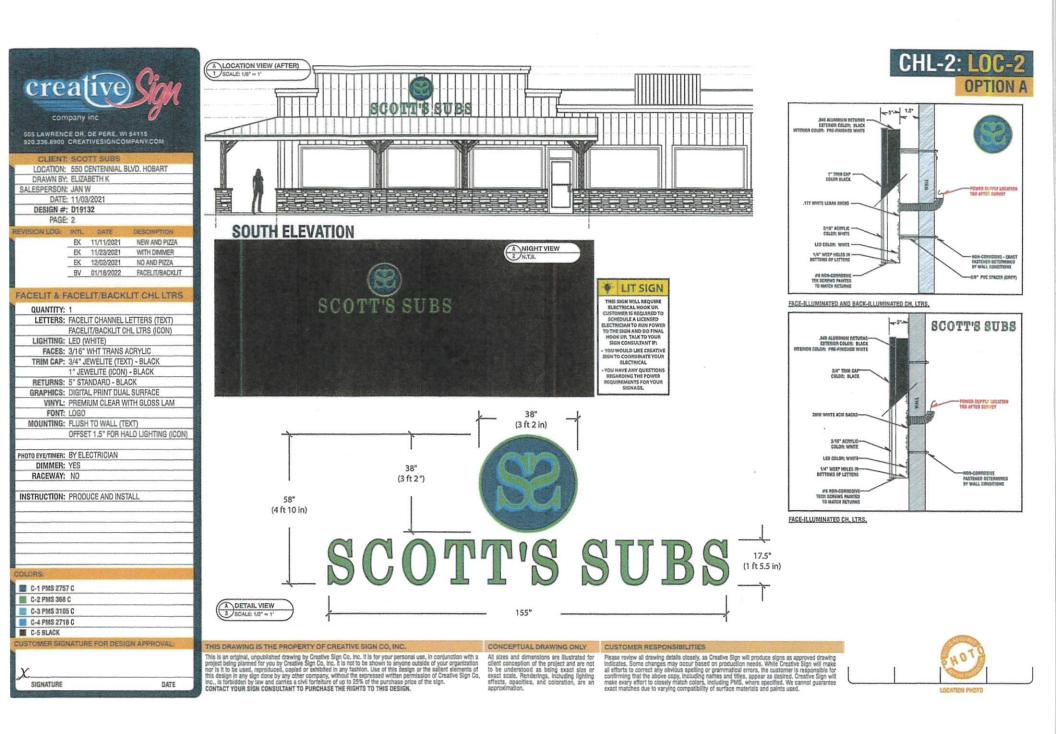
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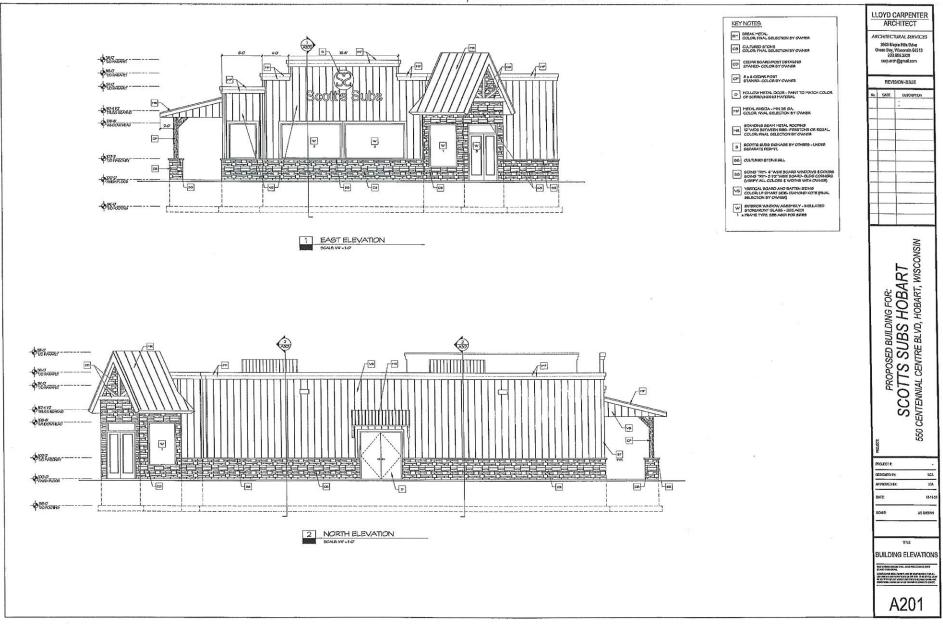
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2021 BUILDING APPROVAL



2

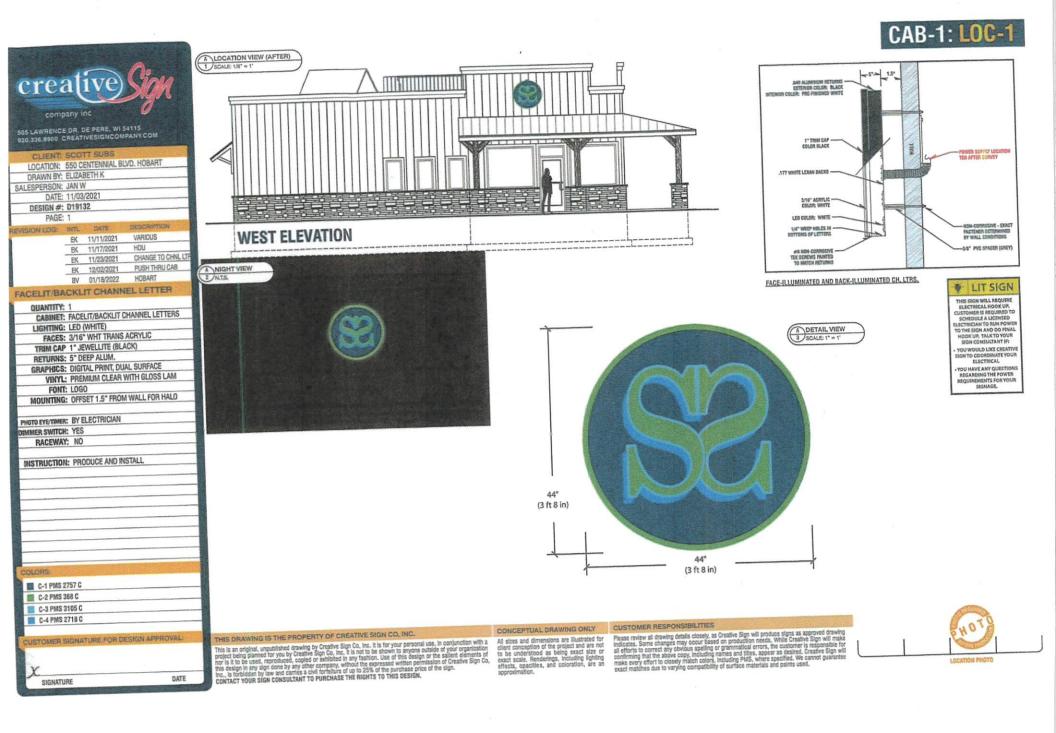2021 BUILDING APPROVAL

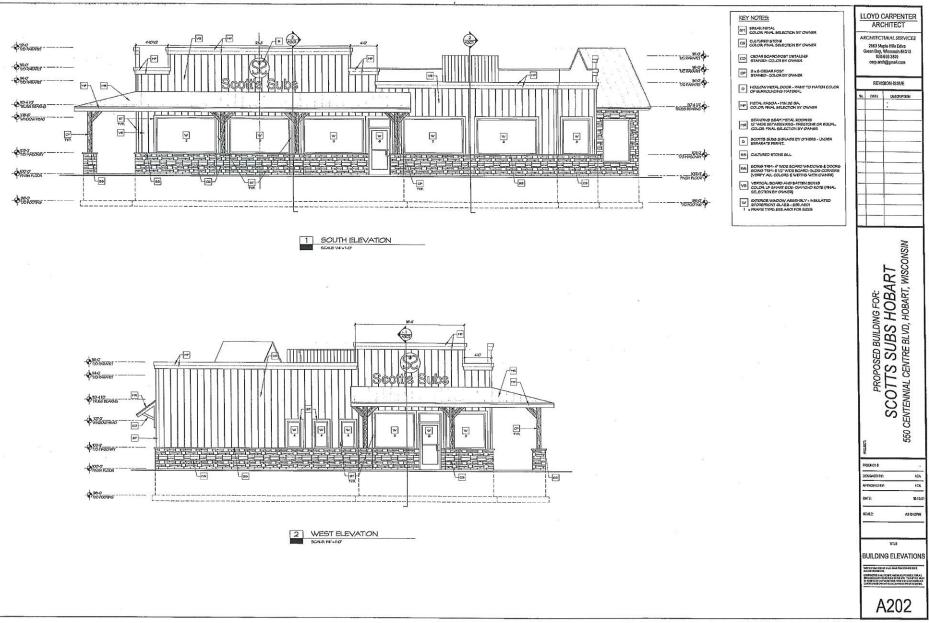

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TO: Site Review Committee RE: 565 Larsen Orchard Parkway, HB-3206; New 3,697 Square Foot Commercial Building

FROM: Todd Gerbers, Director of Planning and Code Compliance

DATE: February 23, 2022

ISSUE: Discussion and action on a new 3,697 square foot commercial building and associated site improvements

RECOMMENDATION: Staff recommends conditional approval of this new development along with any conditions the Committee may identify.

GENERAL INFORMATION

- 1. Developer: Dr. Adam Pasono
- 2. Applicant: Robert E. Lee & Associates
- 3. Address/Parcel: 565 Larsen Orchard Parkway / HB-3206
- 4. Zoning: PDD #1: Centennial Centre at Hobart District
- 5. Use: Business/Office/Clinic

BACKGROUND

This property located along Larsen Orchard Parkway is currently undeveloped, and the proposed project will consist of a new 3,697 square foot, single story, business/dental clinic.

SITE REVIEW DEVELOPMENT AND DESIGN STANDARDS CHECKLIST

Section 1, Site Plan Approval

- A. Zoning: PDD #1: Centennial Centre at Hobart District
- B. Green Space: 72.7% green space proposed.
- **C.** Setbacks: Per the PDD #1 zoning district, "minimum setbacks will be established per the design of the structure". Front setback along Larsen Orchard Parkway 85.9' (to corner of building), 253.4' to east property line, and 63.2' to south property line. All comply with zoning requirements.
- **D. Parking:** 28 spaces proposed, 18 spaces are required per code of 3 stalls per staff member (6 staff members proposed).
- **E.** Fire Dept. (and Police Dept.): The plans presented have been reviewed and accepted by the Police Chief and Fire Chief.
- **F. Storm Water:** Storm water running off of the proposed building and parking areas will be collected by the proposed storm sewer and will be discharged to a dry detention pond on the west side of the development. The southern portion of the pavement will drain to the storm sewer on parcel HB-3207 which discharges to a dry pond on parcels HB-536-1, HB-536-2, HB-3207, and HB-3206. These dry ponds discharge to the Village storm sewer which ultimately discharges to the Centennial Centre regional storm water system that will treat the storm water for TSS removal and peak discharge.

G. Refuse Collection: No additional refuse/recycling enclosure is noted on the site plans. Must be verified that the plan is to utilize the existing enclosure along the south property line and shared with the development to the south.

Section 2, Architectural Plan Approval

- A. Exterior Construction Information:
 - 1. Materials: Wood framed building.
 - 2. Exterior Materials: All four building elevations will be similar with approximately 10' high stone veneer, smart siding (engineered wood-based lap siding) above, and ACM (Aluminum Composite Material) accents near the top.
 - **3.** Height: 21' to top of parapet wall
 - 4. Overhead doors: None
 - 5. Mechanical equipment: None shown, however, if located on the roof or ground, shall be screen from view by materials compatible with the building or landscaping.

Section 3, Landscaping Plan: Required tree planting along the public roadway is noted on plan, however, a greater detailed landscape plan is required to be submitted for review for landscaping adjacent to building.

Section 4, Lighting: Two parking lot light poles are noted in the peninsulas at the corner of the proposed building, however, no light details or building mounted lights is submitted at this time. Shall be submitted for approval prior to installation.

Section 5, Signage: Wall signage is noted on three sides of the proposed building (North, East, and West elevations). However, no sign details are attached so any proposed signage shall be submitted for approval prior to installation.

Section 6, Driveway-Curb Cut: A 26' wide driveway with a 32' curb cut is proposed along Larsen Orchard Parkway and a second ingress/egress will be through a shared location also along Larsen Orchard Parkway.

RECOMMENDATION/CONDITIONS

Staff recommends conditional approval of this site plan in concept only, subject to the following in addition to any conditions the Site Review may identify:

- 1. Detailed landscape plan shall be submitted for approval which includes landscaping around building perimeter, and screening for parking areas located in front of the building (along Larsen Orchard Parkway).
- 2. Details and locations of building mounted lighting and parking lot pole lighting shall be submitted for approval prior to installation.
- 3. Signage details shall be submitted for approval prior to installation.
- 4. Any mechanical equipment if located on the roof or ground, shall be screen from view by materials compatible with the building or landscaping.

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Green Bay Office 1250 Centennial Centre Blvd. Hobart, WI 54155 920-662-9641 FAX 920-662-9141

February 4, 2022

Mr. Aaron Kramer, Village Administrator VILLAGE OF HOBART 2990 S Pine Tree Road Hobart, WI 54155

RE: Hobart Dental Development Storm Water Management Summary

Dear Mr. Kramer:

Robert E. Lee & Associates, Inc., is submitting the following Storm Water Management summary for the proposed Hobart Dental development off of Larson Orchard Parkway in the Village of Hobart. Storm water running off of the proposed building and parking areas will be collected by the proposed storm sewer and will be discharged to a dry detention pond on the West side of the development. The southern portion of the pavement will drain to the storm sewer on parcel HB-3207 which discharges to a dry pond on parcels HB-536-1, HB-536-2, HB-3207, and HB-3206. These dry ponds discharge to the Village storm sewer which ultimately discharge to the Centennial Centre regional stormwater system that will treat the stormwater for TSS removal and peak discharge.

If you have any questions or need any additional information, please do not hesitate to call.

Sincerely,

ROBERT E. LEE & ASSOCIATES, INC.

Brandon D. Robaidek, P.E.

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VILLAGE OF HOBART

SITE REVIEW / DEVELOPMENT AND DESIGN STANDARDS **PROCESS & APPROVAL**

PLAN SUBMITTAL REQUIREMENTS:

- > Fifteen (15) copies 11 x 17 or size that is legible with all information required by this process.
- > Fifteen (15) copies of the Completed Checklist
- > This checklist with complete information no later than ten 10 business days prior to the Third Tuesday of the month to the Village Clerk; NO LATER THAN 1200 HOURS. (Noon)
- > One (1) full size set of site plans.
- > One (1) full size set of building plans, Ready for State Approval
- > All site plans shall be drawn to an engineering scale no greater than one-(1) inch equals one hundred (100) feet.
- > Signs not part of this application would be a considered a separate application
- > Application fee of \$150.

ALL INFORMATION MUST BE COMPLETE PRIOR TO SCHEDULING A MEETING OF THE SITE REVIEW COMMITTEE. NO BUILDING PERMIT WILL BE ISSUED WITHOUT APPROVED PLANS FROM THE SITE REVIEW COMMITTEE.

1. LOCATION

Project / Development / Site Location / intersection (section town & range)

Habart Dartal, Larger Orchard Parkway, Parcel HB-3206

2. TYPE OF DEVELOPMENT

Size of Parcel (acreage or square footage): 2.27 Acces

Size of facility(square footage): 3,619 5.F.

Type of facility: Dental Clinic

Developer: Dr. Adam Pasono

Address: 379 Clermont Ct. De Pare, WI, 54113 Phone: 920-639-1215

Engineer: Brandon Robardek - REL

Address: 1250 Centennial Centre Blud, Blant, uPhone: 920-662-9641 54155 Contractor: Bayland Buildings

Construction Firm:_____

Address: P.O. Bus 13571 Green Bay, WI 54307 Phone: 970-371-6200

Revised 1-23-08

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A.	Industrial Business Park Commercial X
	Multi-Family
	Current Zoning: BD#1- Centennial Centre at Habert District
	Other – Identify:
	Erosion Control Plan on file:X YESNO
	% of Green Space:72.1 /
B.	Orientation – Provide scale map of parcel and facility, (show north indicating arrow, and a graphic scale) $F = B \cup R$
C.	Setback Information: <u>5 - 63.2</u> , 253.4 Complies with Ordinance: <u>Y</u>
D.	# of parking stalls (Include Handicapped parking): 28 stalls
E.	Show the following Utilities and all easements including but not limited to the following facilities types:
	1) Electric underground 📌 overhead 🛛
	2) Natural Gas 🏿
	3) Telephone
	4) Water / Fire Hydrants 🙀
	5) Fiber Optic Lines 🏂
	6) Other transmission lines
	7) Ingress – egress easements
F.	Total Site Build-out including future structures and setbacks:
	Complies with ordinance YES NO
G.	Identify on the Site Plan Key: Spot Elevations: such as Center of Street, Driveway apron, 4 - comers of lot, building elevations, building floor, key drainage points & ditches on local USGS Datum: Data Complete:YESNO

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- H. Adjacent streets and street rights-of-ways and fire lanes:
 - 1) Fire Chief has reviewed and approved: ____YES _X_NO
 - 2) Not applicable_____
- I. Water bodies and wetlands. Over 1-acre disturbed requires storm water plan.
 - 1) Surface water holding ponds, drainage ditches, and drainage patterns, location and size of culverts
 - 2) Name and address and phone# of engineer of project plan:

Brandon Robardek, 1250 Centennial Centre Blud, 920-662.9641

- J. Sidewalks, walkways, and driveways:
- K. Off street loading areas and docks:
- L. Fences and retaining walls or berms:
- M. Location & Size of exterior refuse collection areas (must be enclosed a minimum of three (3) sides):

N/A

N. Location and dimensions of proposed outdoor display areas:

NIA

4. ARCHITECTURAL PLAN APPROVAL

- A. Exterior construction information:
 - 1) Type of Construction Materials: ______
 - 2) Exterior Materials: Stone Voncer + Smart Sidency
 - 3) Height of Facility: 21
 - 4) Compatibility with existing adjacent structure: <u>N/A</u> (Attach Photos)
 - 5) Other unique characteristics:

5. LANDSCAPING PLAN

If planting new trees in Village right-of-way, a requirement of a 1.5" caliper or greater of the tree at 12" above ground is needed, according to planting ordinance specifications. A tree-planting plan must be filed with the application. Tree placement is 1-tree every 50 feet of frontage.

Provide scaled landscaping of plan for parcel

Identify tree and location specifics - Quantity / Diameter, etc:

See, Landscape Plan

Identify Shrubs & Location Specifics - Quantity: _____

Identify Buffering -Type – Quantity:

See landscaping Plan

6. LIGHTING PLAN

Provide scaled lighting plan for parcel Identify Exterior Building Lighting – Quantity, Wattage, Location

See Ste, Plan sheet 2

Identify Parking Lighting - Quantity - Wattage - Location

Identify other Lighting – Quantity – Wattage – Location:

7, SIGNAGE

8.

Provide scaled drawings.
Provide Site Plan for signage
Provide building elevations with signage.
Discussion:
Complies with Ordinance:YESNO
Date:
DRIVEWAY – CURB CUT
Width of Curb Cut: <u>32</u>
Radius / Flare: 3' Flore
Apron Dimensions: 26° @ Sidewalk, 32° @ roadway
Culvert Size (End-walls Required)//

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Storm Water Utility Service Application

A. Applicant

Applicant Name: Brandon Robaidek	Owner Name: Dr. Adam Pasono
Address: 1250 Centermal Centre Blud	Address: 379 Clermont Ct
City: Hobert State: WT Zip: 54155	City: <u>De Pere</u> State: <u>WI</u> Zip: <u>54/15</u>
Phone: (920) (112 - 9641	Phone: (<u>920</u>) <u>639 - p.15</u>
Email: brobaidek@releinc.com	Email: <u>adampasono @.gmail.con</u>
B. Parcel – Site Information	
Site Address: 565 Larsen Orchard Pkwy	Parcel ID: HB-3206

Project Description: Dental Clinic

Residential ERU Calculations

Use	Single Family	Duplex	Multi-family
Number of Dwellings			
ERU's / Dwelling	1 ERU	0.75 ERU	0.6 ERU
Total ERU's			

Nonresidential Uses - Impervious Surface Calculation

	Existing		Change (+/-)		= New Total Area	
Building/Structure Foot Prints		sq. ft.	3,679	sq. ft.	3,679	sq. ft.
Paved/Gravel Areas	1463	sq. ft.	21,879	sq. ft.	23,342	sq. ft.
Totals	1463	sq. ft.	27,021	sq. ft.	27,021	sq. ft.

ERU Calculation:	27,021	/ 4000 sf / ERU =	6.76	ERU's
12-1	New Total Are	a sq. ft.		
Preparer's Signature:	Bh	hah		Date:]-26-22

Preparer's Printed Name: Brandon Roba: dek

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Site Plan Review Checklist					
Project: Hobart Dental					
PDD ORDINANCE, SITE PLAN REQUIREMENT	LOCATION, PLAN SHEET(PS) or MAP	PRESENT AND SATISFIES REQUIREMENT?	COMMENTS		
a. Name of project/development;	REL Sheet C	Y			
b. Location of project/development by street address, or CSM	REL Sheets 1-4	Y			
c. Name and mailing address of developer/owner;	REL Sheet 1	Y			
d. Name and mailing address of engineer/architect;	REL Sheets 1-4	Y			
 e. A written statement describing how the development will be consistent with the land use and design guidelines as identified in the <u>Centennial Centre Master Plan</u>. f. A written statement from the Owner acknowledging the Village's Restrictive Covenants for the District set forth on <u>Appendix A and agreeing</u>: to subject the real estate that is subject to the Site to the Restrictive Covenants if said property has not been previously subjected to the Restricted Covenants; and 					
ii. to be individually bound by the terms of the Restrictive Covenants, including the waiver of sovereign immunity set forth therein.		Y			
g. North point indicator;	REL Sheet 1-4	Y			
h. Scale;	REL Sheet 1-4	Y			

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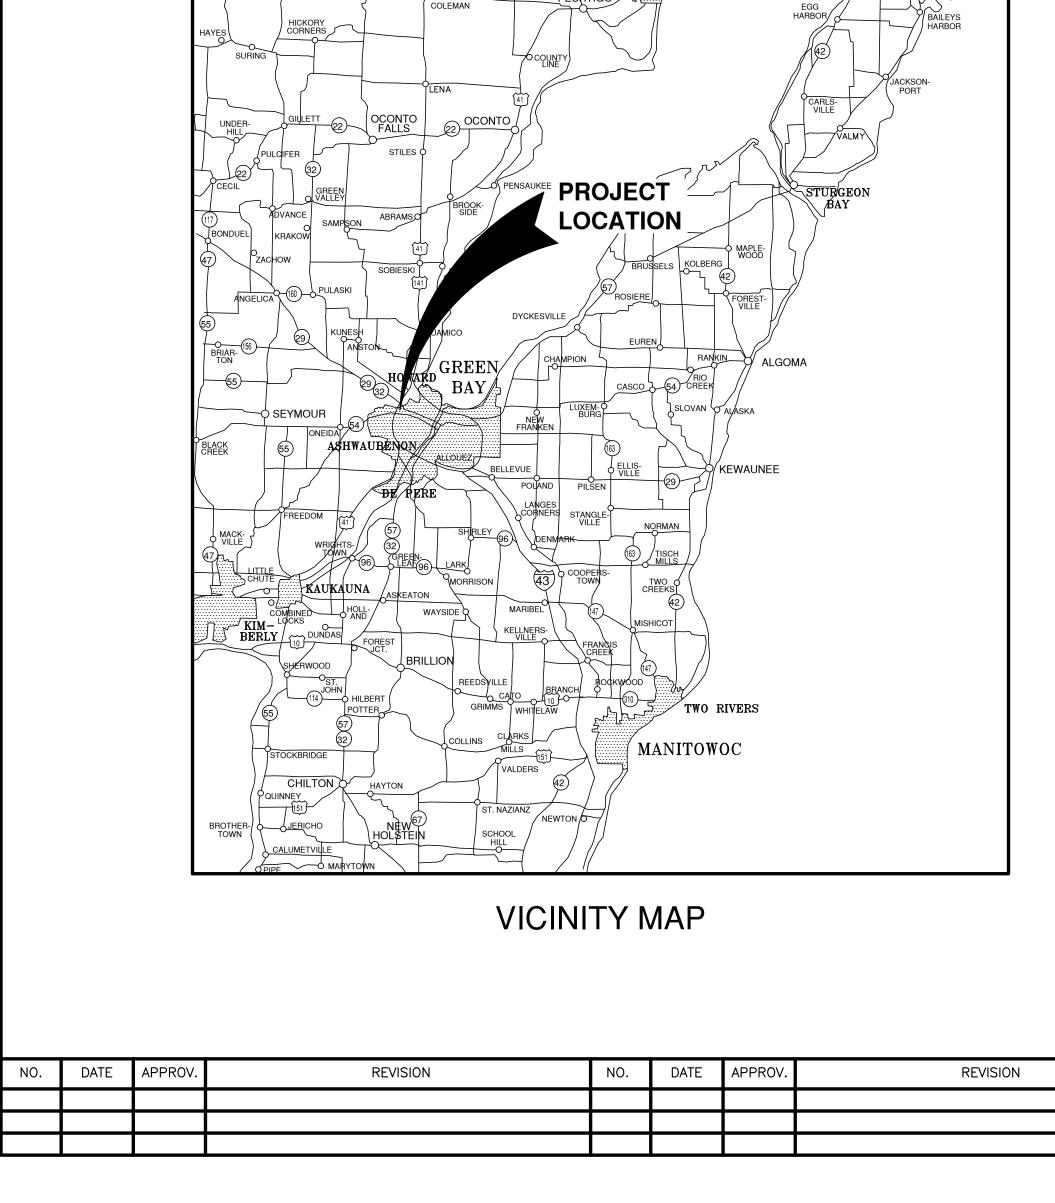
Site Plan Review Checklist					
Project: Hobart Dental					
PDD ORDINANCE, SITE PLAN REQUIREMENT	LOCATION, PLAN SHEET(PS) or MAP	PRESENT AND SATISFIES REQUIREMENT?	COMMENTS		
i. Boundary lines of property, with dimensions;	REL Sheet 1	Y			
j. Location identification, and dimensions of existing and proposed:					
i. Topographic contours at a minimum interval of two feet, and key spot elevations;	REL Sheets 1,4	Y			
ii. Adjacent streets and street right of ways, respective to the elevation of building first floor;	REL Sheet 1-4	Y			
iii. On site streets and street right of ways, and fire lanes;	REL Sheet 1-4	Y			
iv. Utilities and any easements including but not limited to the following types;	REL Sheets 1,3	Y			
v. All buildings and structures, existing & proposed to consider maximum development of the parcel if more than one structure could be located on the parcel;	REL Sheet 1-4	Y			
k. A statement of the total acreage of the property to be developed;	REL Sheet 2	Y	0.9 ACRES PROJECT 2.27 ACRES LOT		
 Significant physical features within the tract, watercourses, ponds, lakes, rain gardens, and wetlands; and proposed major changes in those features; 	REL Sheet 1-4	Y			
m. All contemplated land uses;	REL Sheets 1-4	Y			
n. An indicator of the contemplated intensity of use: i.e., gross density in residential development;	N/A	N/A	N/A		

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Site Plan Review Checklist						
Project: Hobart Dental						
PDD ORDINANCE, SITE PLAN REQUIREMENT	LOCATION, PLAN SHEET(PS) or MAP	PRESENT AND SATISFIES REQUIREMENT?	COMMENTS			
o. Existing buildings that will be removed and the proposed location of all principal structures and associated parking areas;	REL Sheet 1	Y				
 p. Proposed circulation systems (pedestrian, bicycle, auto) by type, their connection to the existing network outside the site; 	REL Sheet 1-4	Y				
q. Existing rights-of-way and easements that may affect the project;	REL Sheets 1,2	Y				
r. The location of sanitary and storm sewer lines and water mains;	REL Sheets 1,3	Y				
s. The location of recreational and open space areas;	REL Sheet 2-4	Y				
t. Description of proposed system for drainage and a storm water plan showing existing and final grades.			NARRATIVE			
i. Parking facilities;	REL Sheet 2-4	Y				
ii. Water bodies and wetlands;	REL Sheet 1-4	Y				
iii. Surface water holding ponds , drainage ditches, and drainage patterns, location and size of culverts and any drainage sewers servicing the site	REL Sheets 2-4	Y				
u. Sidewalks, walkways, and driveways;	REL Sheet 2-4	Y				
v. Off street loading areas and docks;	N/A	Y				
w. Fences and retaining walls;	N/A	Y				
x. All signs;	REL Sheet 2	Y				

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Site Plan Review Checklist					
Project: Hobart Dental					
PDD ORDINANCE, SITE PLAN REQUIREMENT	LOCATION, PLAN SHEET(PS) or MAP	PRESENT AND SATISFIES REQUIREMENT?	COMMENTS		
y. Exterior refuse collection areas and the required enclosure(s);	N/A	Y			
z. Exterior lighting;	REL Sheet 2	Y			
aa. Traffic flow on and off site.	REL Sheet 2	Y			
bb. Location of open space/green space;	REL Sheet 2	Y			
cc. Site statistics, including:					
i. Sq. Footage	REL Sheet 2	Y	98,829 SF		
ii. Percent site coverage;	REL Sheet 2	Y	27.30%		
iii. Percent open space; and green space	REL Sheet 2	Y	72.70%		
iv. Floor area ratio (FAR)	REL Sheet 2	Y	0.037		
dd. Location and dimensions of proposed outdoor display areas;	N/A	N/A			
ee. Architectural rendering of the proposed structures and buildings, including:	Аю				
i. All dimensions;	A1.0,A2.0,A3.0				
ii. Gross square footage of existing and proposed buildings and structures; and	A1.0	Y			
iii. Description of all exterior finish materials.	A2.0,A3.0	Y			
ff. Erosion control plans;	REL Sheets 4, 7-10	Y			
gg. Landscaping plan	REL Sheets 2	Y			



MENOMINEE

MARINETTE

HOBART DENTAL FOR BAYLAND BUILDINGS, INC. **VILLAGE OF HOBART BROWN COUNTY, WISCONSIN**

NOTE:

EXISTING UTILITIES SHOWN ON PLANS ARE APPROXIMATE. THE CONTRACTOR SHALL BE RESPONSIBLE FOR OBTAINING EXACT LOCATIONS AND ELEVATIONS OF ALL UTILITIES, WHETHER SHOWN OR NOT, FROM THE OWNERS OF THE RESPECTIVE UTILITIES. ALL UTILITY OWNERS SHALL BE NOTIFIED FOR LOCATES BY THE CONTRACTOR 72 HOURS PRIOR TO EXCAVATION.

> NOTE: ALL EROSION CONTROL MEASURES SHALL BE IN PLACE PRIOR TO CONSTRUCTION AND SHALL CONFORM TO THE WISCONSIN DEPARTMENT OF NATURAL RESOURCES CONSTRUCTION SITE EROSION CONTROL AND TECHNICAL STANDARDS.


INDEX TO DRAWINGS

SHT. NO.


LOCATION MAPS AND INDEX TO DRAWINGS С EVICTING SITE CONDITIONS

DESCRIPTION

LOCATION MAP
PRELIMINARY Not for Construction
MAP AND INDEX TO DRAWINGS JOB NO. 2035412 DATE 01/2022 FILE 2035412 FILE 20355 FILE 203555 FILE 20355 FILE 20355 FILE 2
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ATTENTION! DOWNLOADED PLANS ARE NOT SCALEABLE, NEITHER THE OWNER OR THE ENGINEER SHALL BE HELD RESPONSIBLE FOR THE SCALE OR PRINT QUALITY OF DOWNLOADED PLANS. ONLY PRINTED PLANS FROM BLUE PRINT SERVICE CO., INC. SHALL BE CONSIDERED TO BE SCALEABLE PLANS.

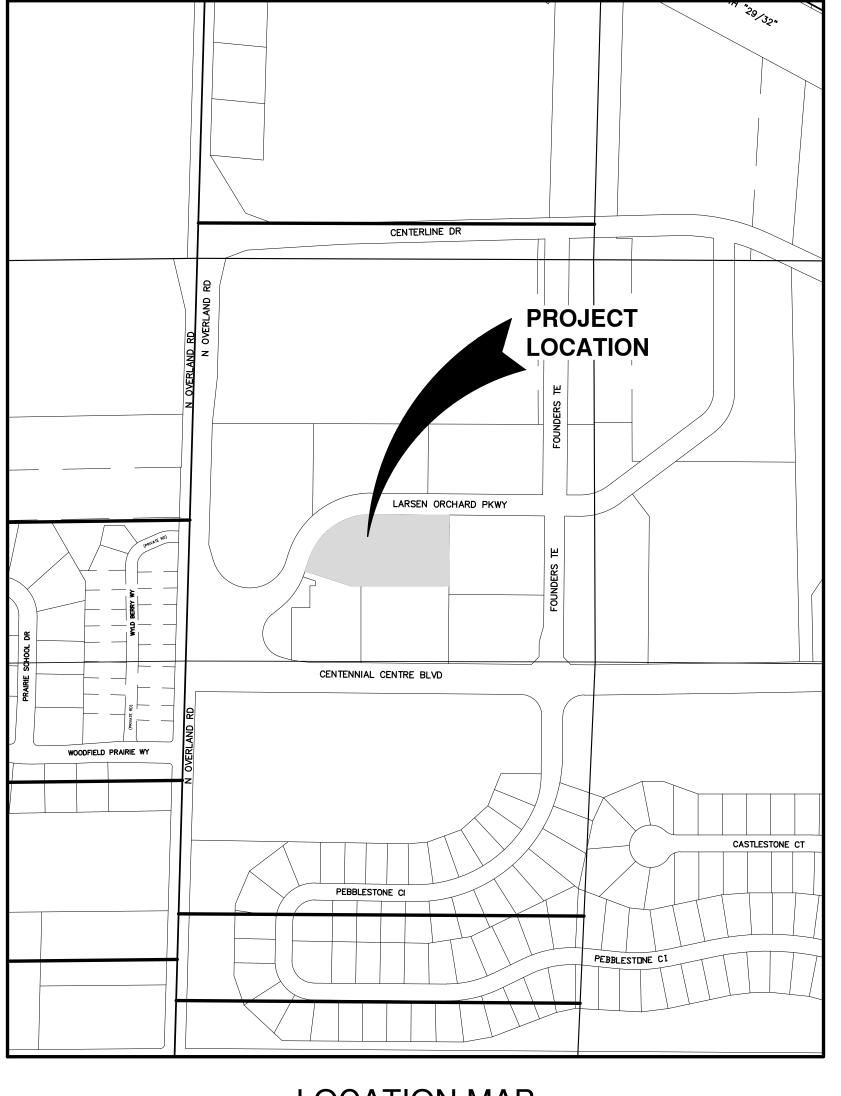

	OWNER INFORMATIO	N:	CONTRA	CTOR	INFORMATION:
	DR. ADAM PASONO 379 CLERMONT COURT		BAYLAND BUIL P.O. BOX 1357	DINGS, IN	-
	DE PERE, WI 54115		GREEN BAY, W		
	(920) 639-1215		(920) 371-6200 CONTACT: DA		ΞN
	UTILITY INFORMATIC	N:			
	UTILITIES PRESENT: VILLAGE OF HOBART DEPARTMENT WARNER CABLE AND NSIGHT.	OF PUBLIC WOR	KS, WISCONSIN	PUBLIC SE	ERVICE CORP., TIME
	UTILITIES SHOWN ON THIS MAP ARE	BASED ON LOC	ATES FROM:		
	DIGGER'S HOTLINE TICKETS NUMBE OBSERVATION AND RECORD UTILITY PRIOR TO ANY DIGGING. THIS SITE	Y PLAN DOCUME	INTS. UTILITY LI	NÉ LOCATI	ONS SHOULD BE VERIFIED
	DIGGERS HOTLINE = 1-800-242-8511 WATER/SANITARY/STORM SEWER: DEPARTMENT OF PUBLIC WORKS VILLAGE OF HOBART 2990 S. PINE TREE RD. HOBART, WI 54155 (920) 869-3807	GAS & ELECTF WISCONSIN PU 700 N. ADAMS GREEN BAY, W (800) 797-7434	JBLIC SERVICE C ST.	CORP.	TELECOMMUNICATIONS: TIME WARNER CABLE 2580 W. MASON ST. GREEN BAY, WI 54303 (920) 944-1581
1	TELECOMMUNICATIONS: NSIGHT C/O MI TECH SERVICES 1700 INDUSTRIAL DR.	DIGGERS	HOTLINE	UNDEF	TAIN LOCATION OF PARTICIPANT RGROUND FACILITIES BEFORE YO WISCONSIN
	GREEN BAY, WI 54302	ial 🛺 or (8	:00) 242-8511	WIS. S	STATUTE 182.0175 (1974) RES MIN. OF 3 WORK DAYS
	(920) 288-8908	www.Digger	sHotline.com		E BEFORE YOU EXCAVATE.
		LEGEN	VD		
	 → FIRE HYDRANT ⊗ WATER VALVE/CURB STOP Ŵ WATER MANHOLE ▽ REDUCER/INCREASER → SANITARY MANHOLE ● AIR RELIEF MANHOLE 	LIGHT POI	ole W/GUY Wire Le Signal Pole : Manhole		DECIDUOUS TREE CONIFEROUS TREE BUSH RIP RAP
	STORM MANHOLEOPEN STORM MANHOLE	0	NE MANHOLE NE PEDESTAL		CULVERT
	STORM INLETSTORM INLET MANHOLE	0	MANHOLE PEDESTAL	· · · · ·	WETLANDS
	IC TANK COVER ⊕ SOIL BORING	© GAS VALV © GAS METE	—	Ļ	HANDICAP PARKING
	■ POST ■ IRON PIPE/ROD	MAILBOX ∮ SIGN			
	△ PK NAIL	BOLLARD			
	EDGE OF	ASPHALT		—— Forc	TARY SEWER (SIZE NOTED) CEMAIN (SIZE NOTED) RM SEWER (SIZE NOTED)
	EDGE OF	GRAVEL		—— WATE	ERMAIN (SIZE NOTED)
	CURB & G	iUTTER	от т		RHEAD TELEPHONE LINE ERGROUND TELEPHONE LINE
-	TREE/BRI				RHEAD ELECTRIC LINE
	CONTOUR		OTV		RHEAD CABLE TV LINE E TV LINE
		G WALL	F0	FIBER	R OPTIC LINE LINE
	-oo	AIL			PERTY LINE
				BUILE	DING SETBACK LINE
	BENCHMA	RK ROBERT E. LE	ESTABLISHED BY: EE & ASSOCIATES, INC.		
ŀ	NO.	DESCRIPTIO	Y BENCHMARKS FOR ACC	EL.	
		TAG BOLT ON HY	/DRANT	756.07	

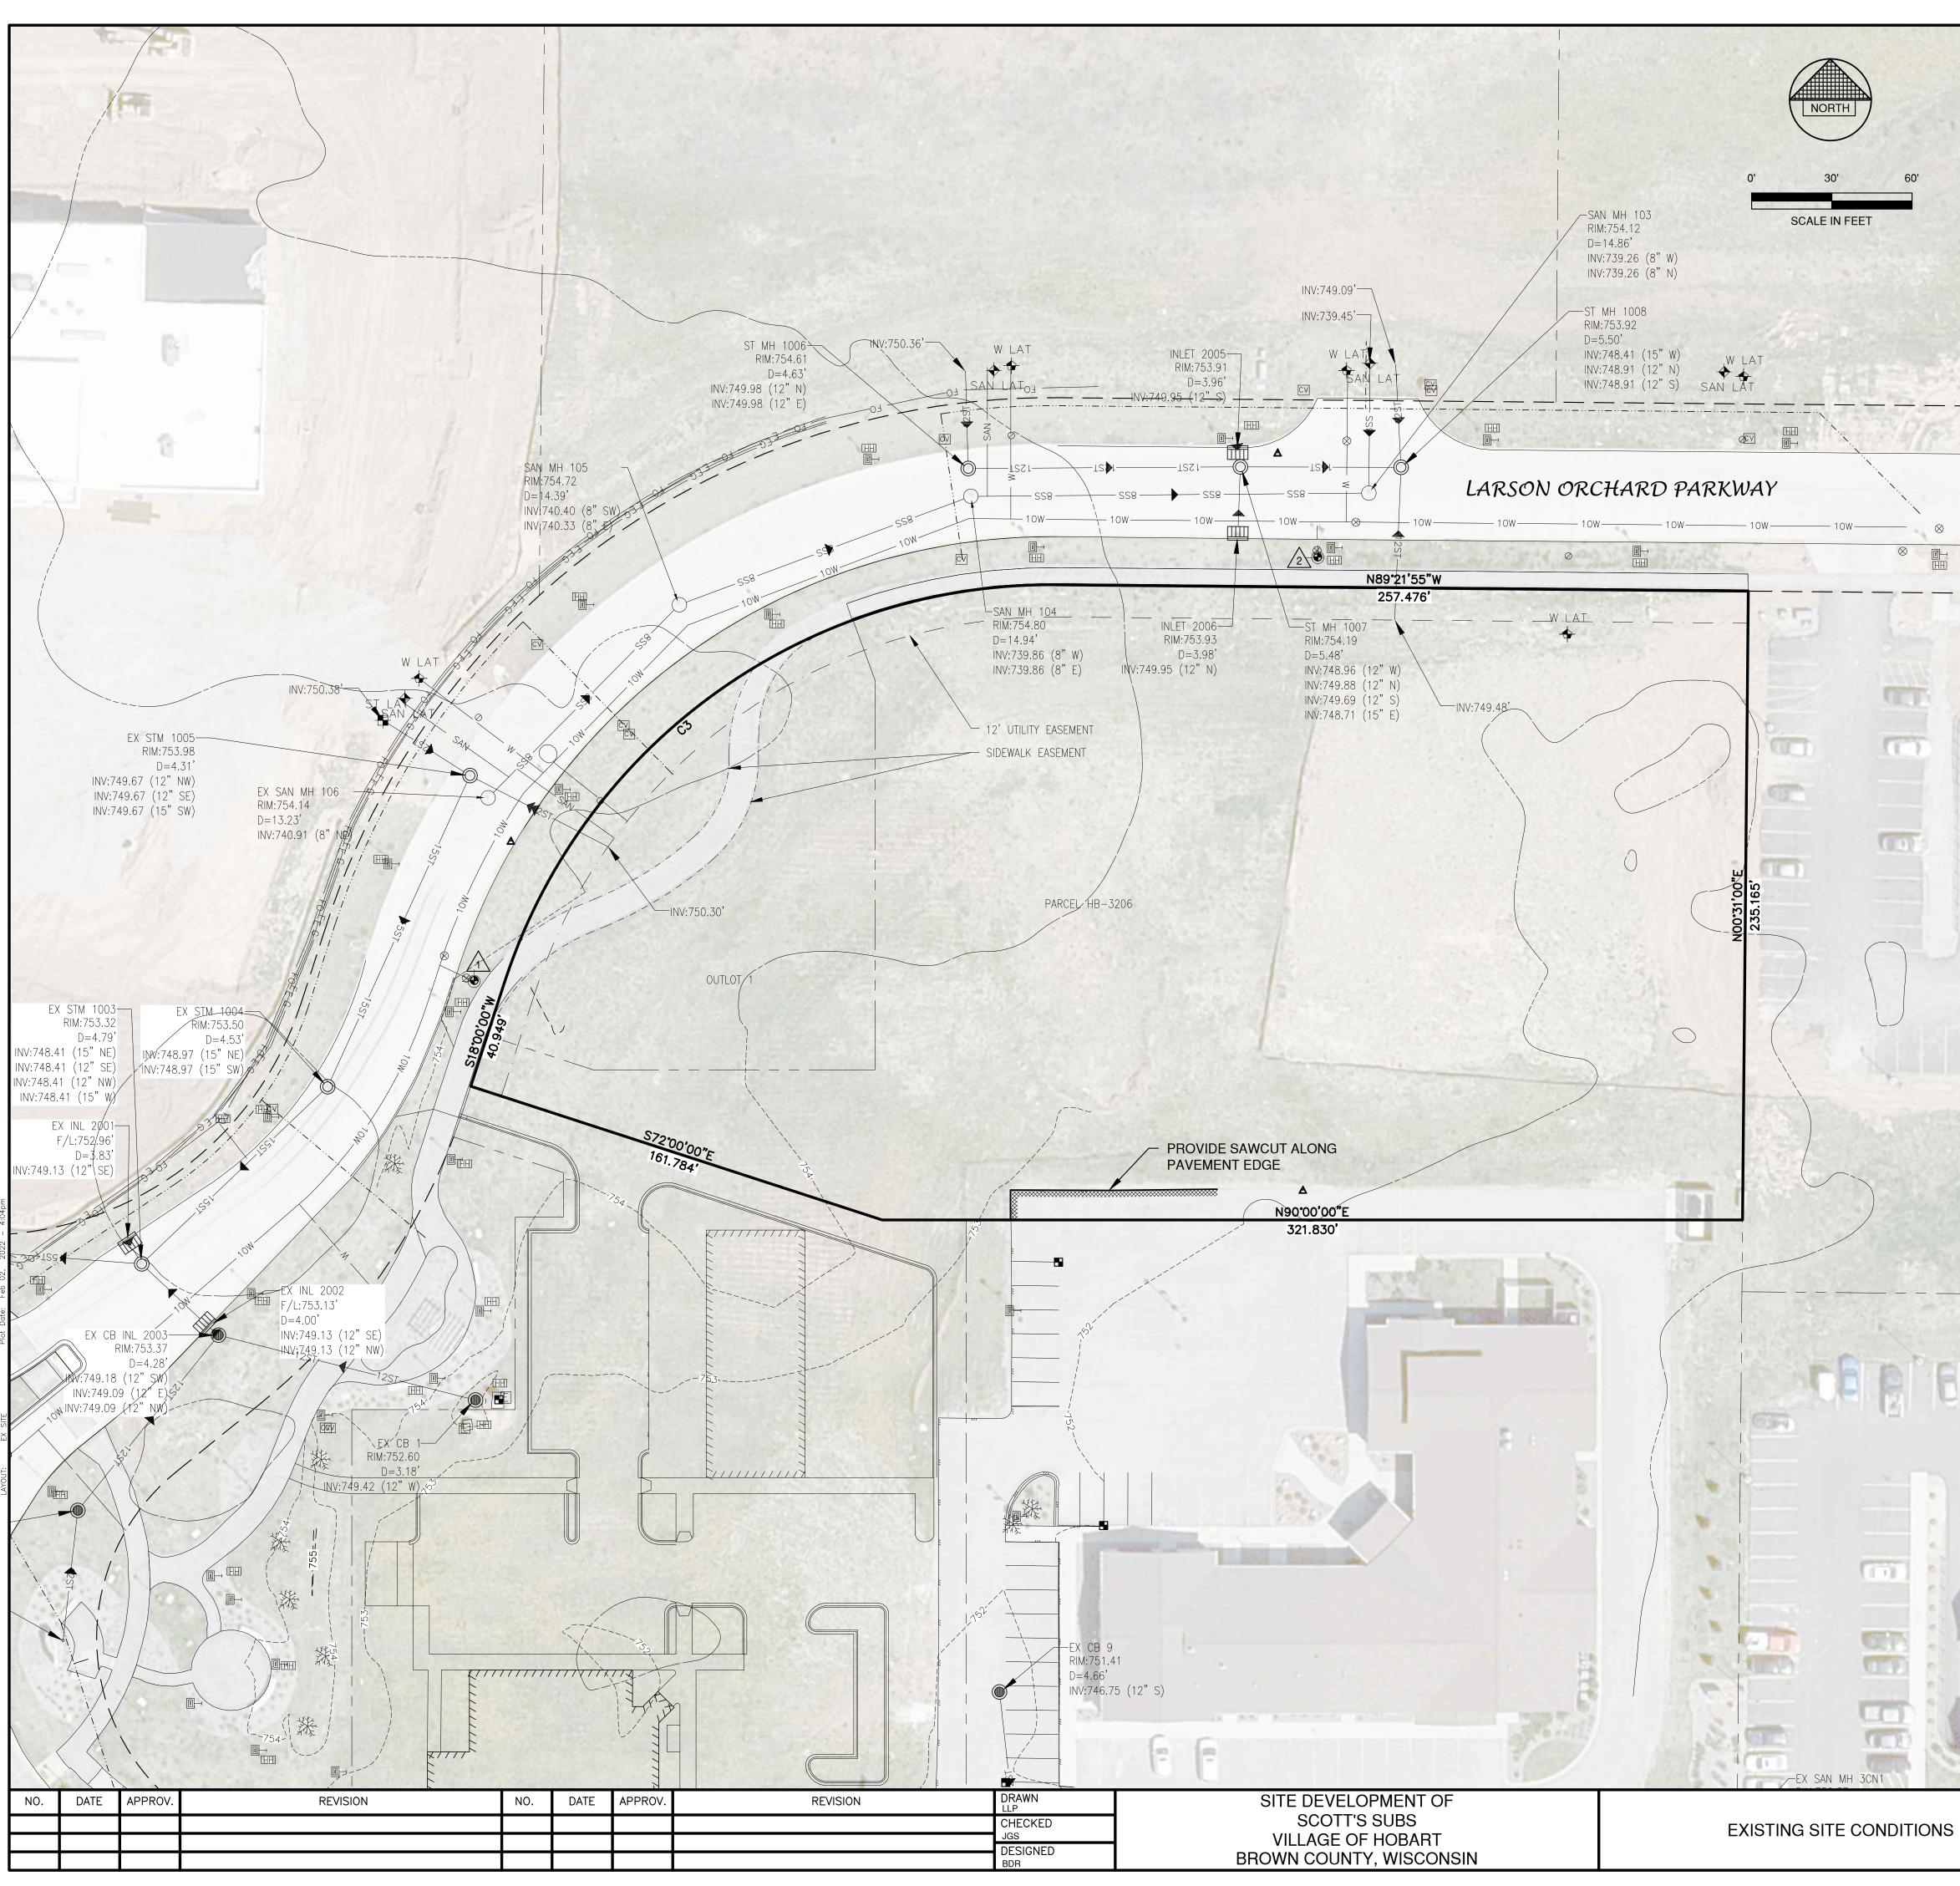
Curve Table Curve # Delta Radius Length Chord Direction Chord Length Tangent Bearing Second Tangent Bearing C3 72°31'00" 215.00' 272.11' S54°15'30"W 254.31' N89°29'00"W S18 00' 00"W

756.24

TAG BOLT ON HYDRANT

2

DATE SHEET NO. **Robert E. Lee & Associates, Inc. ENGINEERING, SURVEYING, ENVIRONMENTAL SERVICES** 1250 CENTENNIAL CENTRE BOULEVARD HOBART, WI 54155 920-662-9641 www.releeinc.com 09/2021 FILE 2035412BASE JOB NO. 6252001

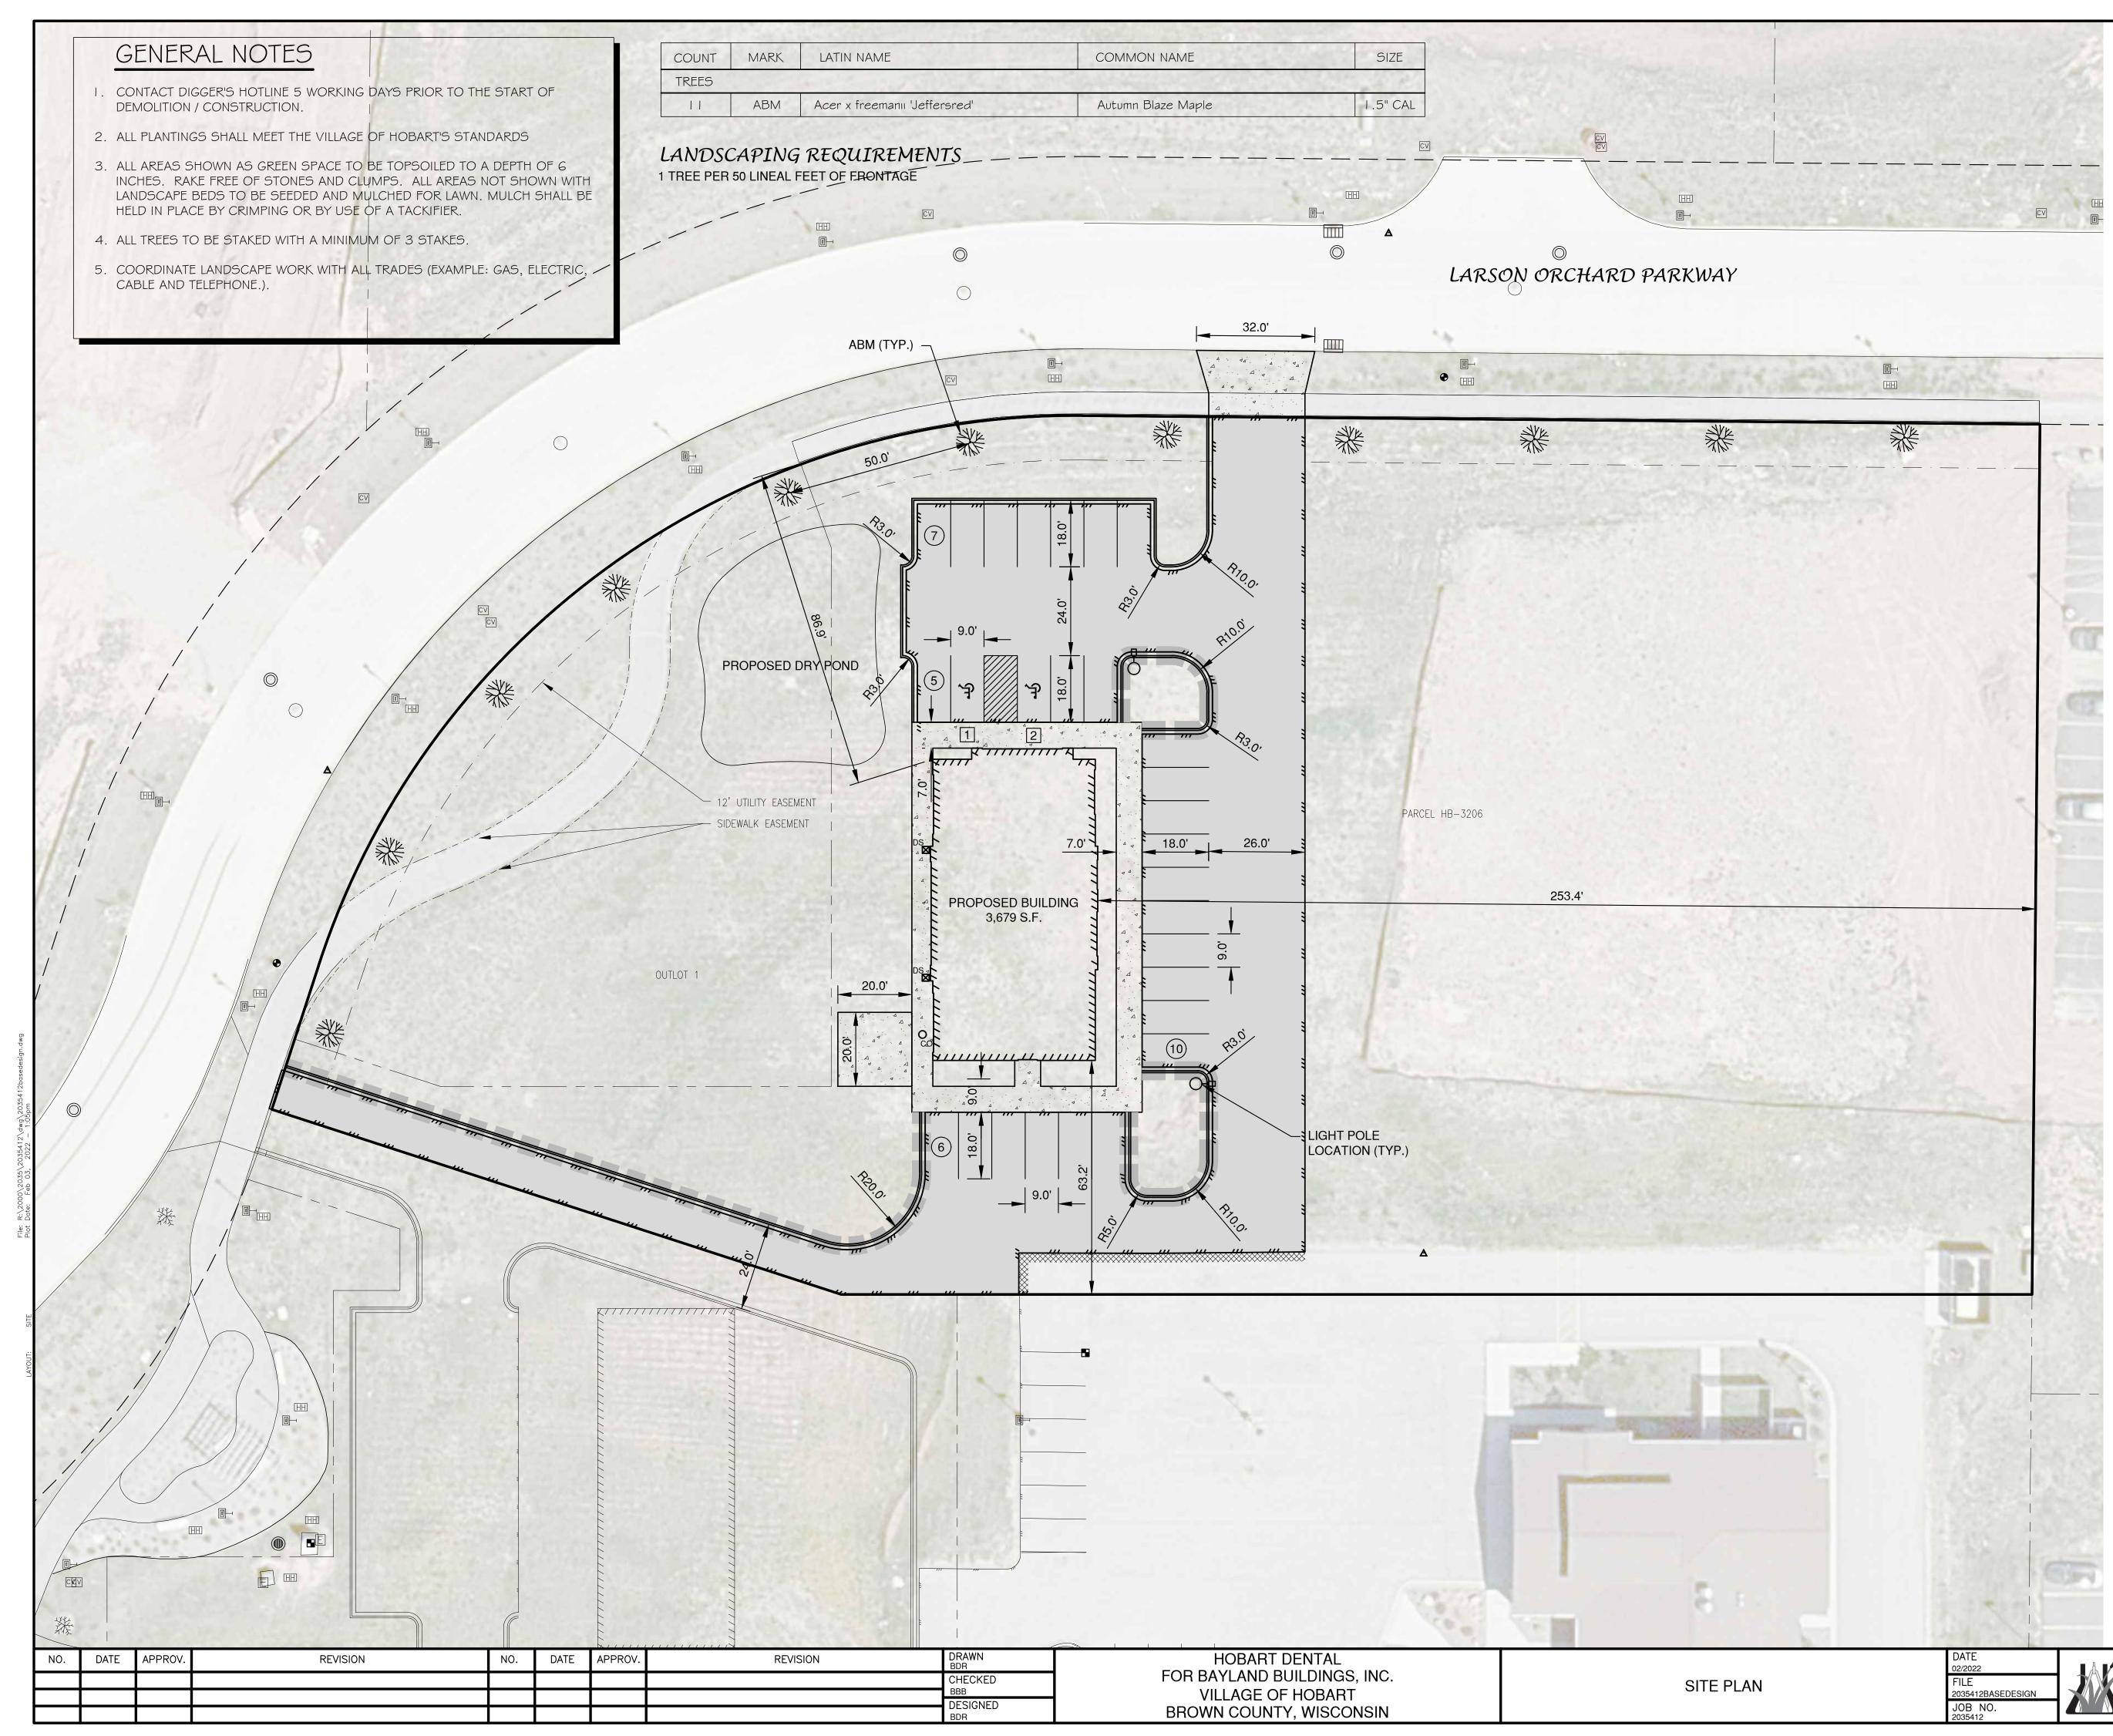



LEGEND CONCRETE PAVEMENT ASPHALT PAVEMENT (LIGHT) (16,247 S.F.) LANDSCAPE AREA **GREEN SPACE** * * * *

PROPOSED 18" MOUNTABLE CURB AND _____ GUTTER

PROPOSED 18" MOUNTABLE SHEDDING CURB AND GUTTER

TRAFFIC FLOW ARROW \rightarrow


HANDICAPPED PARKING

INDICATES NUMBER OF PARKING STALLS (12)

LIGHT POLE (1 LAMP)

*NOTE:

ALL DIMENSIONS ARE TO THE FACE OF CURB, UNLESS NOTED OTHERWISE

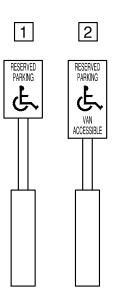

NOTE

ALL DISTURBED AREAS SHALL BE TOPSOILED TO A DEPTH OF 6 INCHES, SEEDED AND MULCHED. AREA TO BE RAKED FREE OF STONES AND CLUMPS.

PARKING DATA

TOTAL PARKING STALLS PROVIDED = 28 HANDICAP ACCESSIBLE PARKING STALLS = 2 TOTAL PARKING STALLS REQUIRED = 18

3 STALLS PER STAFF MEMBER AND DOCTOR Х


6 STAFF MEMBERS = 18 STALLS

SITE DATA

TOTAL AREA = 2.27 ACRES, 98,829 S.F. BUILDING AREA = 0.08 ACRES, 3,679 S.F. (3.7%) SIDEWALK/PARKING LOT AREA = 0.54 ACRES, 23,342 S.F. (23.6%) GREEN SPACE = 1.65 ACRES, 71,808 S.F. (72.7%)

ZONING PDD #1 - CENTENNIAL CENTRE AT HOBART DISTRICT

PARCEL NO. HB-3206

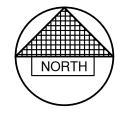


SCALE IN FEET

PRELIMI Not for Consti	
	SHEET NO

Robert E. Lee & Associates, Inc. ENGINEERING, SURVEYING, ENVIRONMENTAL SERVICES 1250 CENTENNIAL CENTRE BOULEVARD HOBART, WI 54155 920-662-9641 www.releeinc.com

2

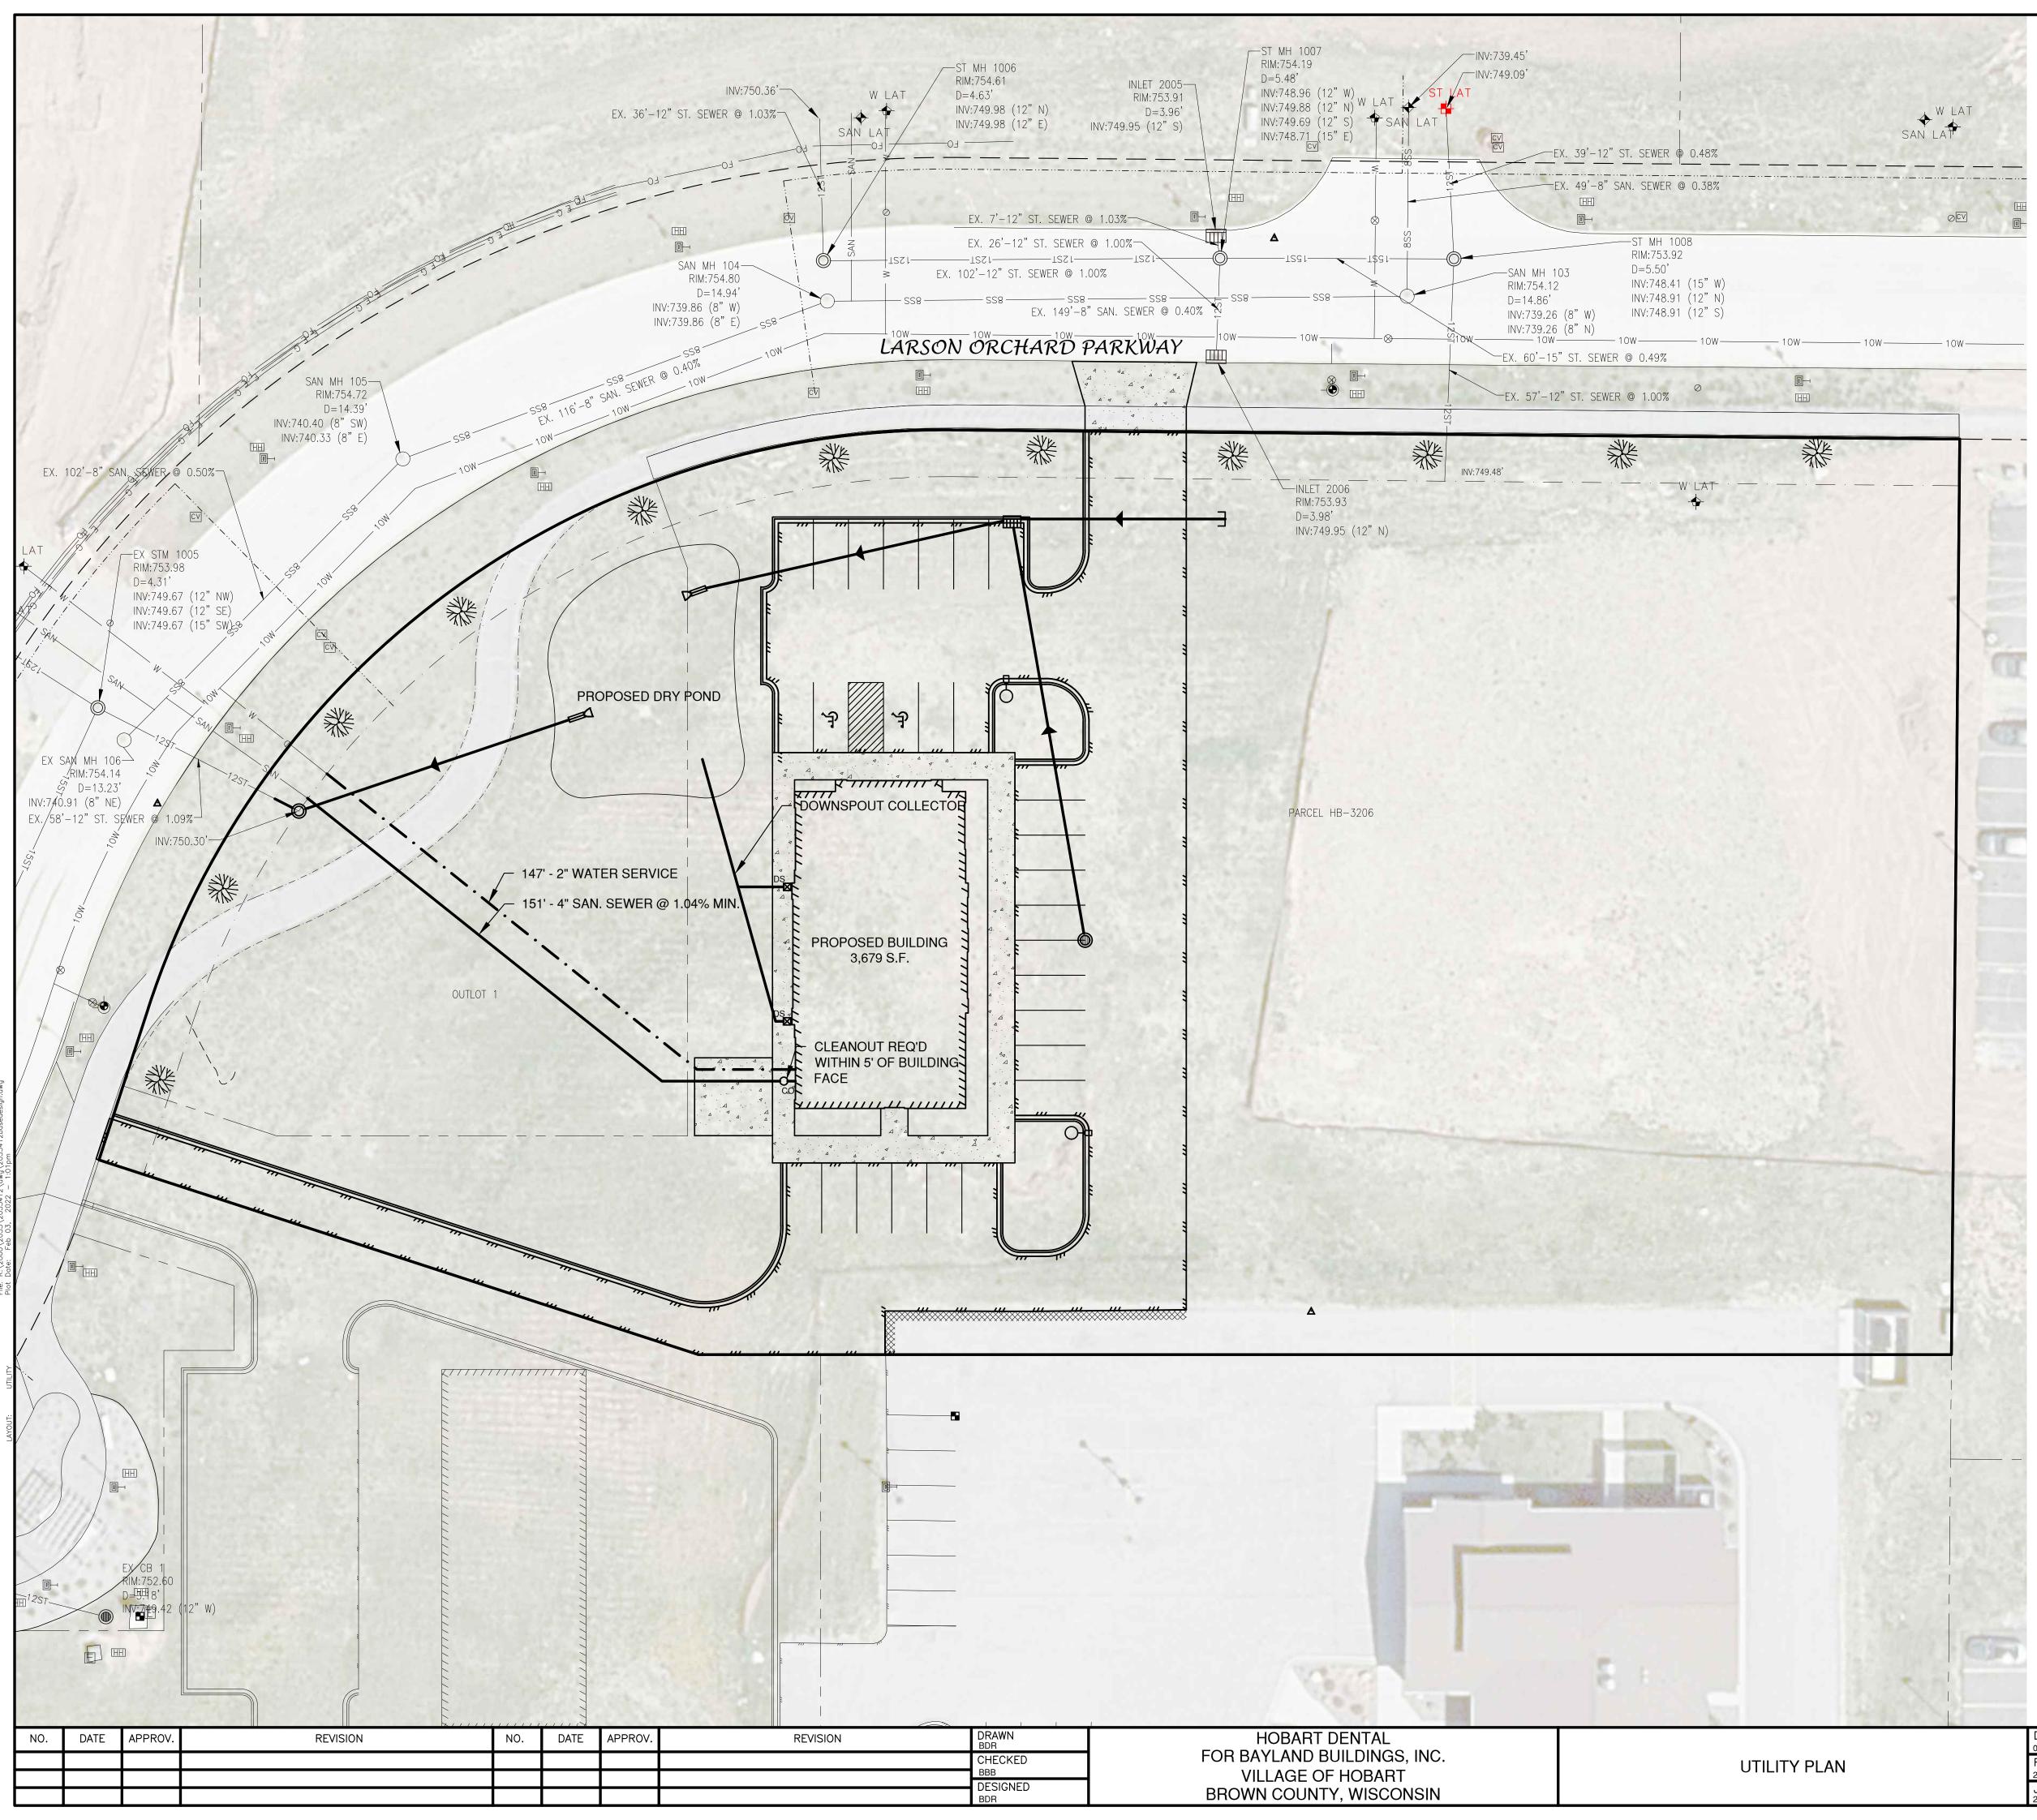


<u>PAGE 25</u>

	LŦ	EGEND
		- PROPOSED SANITARY SEWER - EXISTING SANITARY SEWER (SIZE NOTED)
10ST		- PROPOSED STORM SEWER - EXISTING STORM SEWER (SIZE NOTED)
		- PROPOSED WATERMAIN - EXISTING WATERMAIN (SIZE NOTED)
	G SED	

PROPOSE	EXISTING	
RO	SIX	
-0	ш 	FIRE HYDRANT
8	\otimes	WATER VALVE/CURB STOP
(W)	(W)	WATER MANHOLE
∇	\bigtriangledown	REDUCER/INCREASER
0	\bigcirc	SANITARY MANHOLE
D	0	LIFT STATION
•	0	TRACER WIRE SIGNAL CONNECTION BOX
O _{CO}	O _{CO}	CLEANOUT
Ô	\bigcirc	STORM MANHOLE
		STORM CATCH BASIN
		STORM INLET
	\Box	STORM INLET MANHOLE
		YARD DRAIN
\bullet	\bigcirc	STANDPIPE
	\boxtimes_{DS}	ROOF DOWNSPOUT
		DISCHARGE STRUCTURE

NOTE

- 1. A MINIMUM OF 6.5 FEET OF COVER SHALL BE MAINTAINED OVER ALL WATERMAIN.
- SANITARY SEWER, WATERMAIN AND STORM SEWER SHALL BE 2. CONSTRUCTED IN ACCORDANCE WITH THE STANDARD SPECIFICATIONS FOR SEWER AND WATER CONSTRUCTION IN WISCONSIN AND ADMINISTRATIVE CODE CHAPTERS COMM 81-87.
- 3. FIELD VERIFY LOCATION OF EXISTING UTILITIES. IF EXISTING LOCATIONS DIFFER FROM WHAT IS INDICATED ON THE PLANS, CONTACT ENGINEER, PRIOR TO CONTINUED WORK.
- 4. ALL SANITARY SEWER, STORM SEWER AND WATER SERVICES / MAINS SHALL BE PROVIDED WITH TRACER WIRE OR OTHER METHOD TO BE LOCATED.

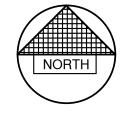


SCALE IN FEET

TE
2022
E
5412BASEDESIGN
B NO.
5412

Robert E. Lee & Associates, Inc. ENGINEERING, SURVEYING, ENVIRONMENTAL SERVICES 1250 CENTENNIAL CENTRE BOULEVARD HOBART, WI 54155 920-662-9641 www.releeinc.com

PRELIMINARY Not for Construction SHEET NO. 3

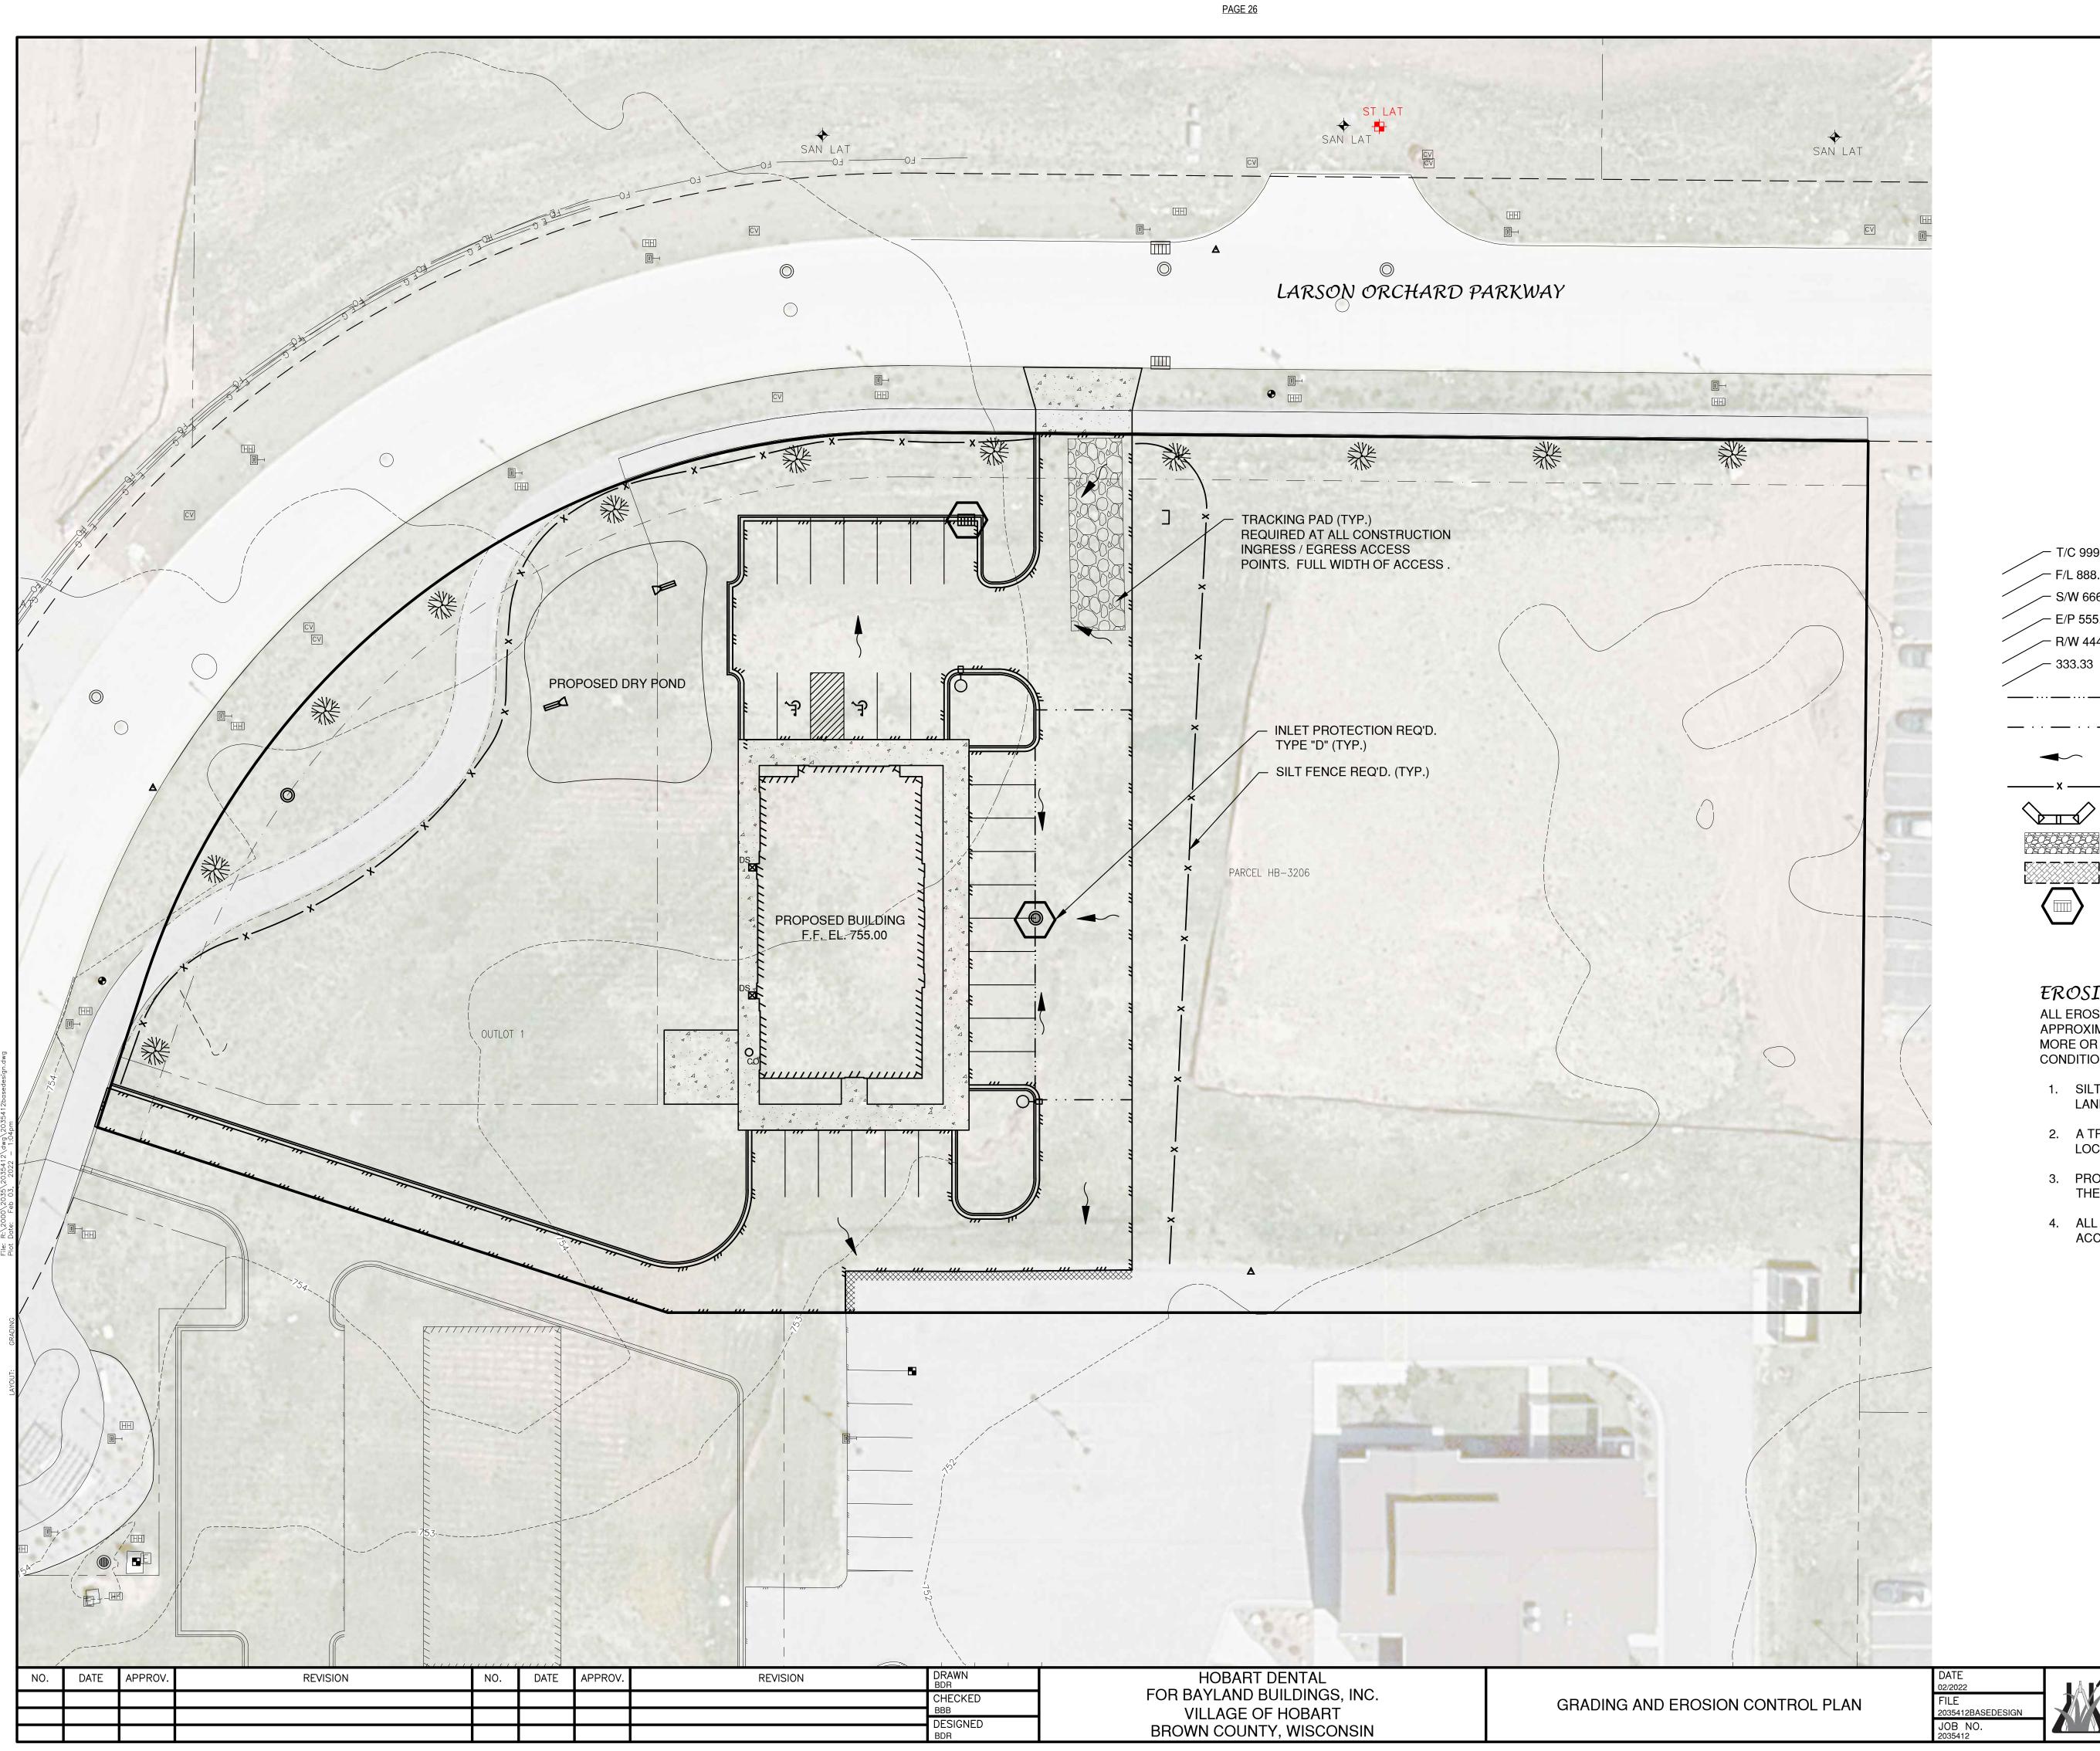

- T/C 999.99 ← F/L 888.88 - S/W 666.66 - E/P 555.55 - R/W 444.44 ~ 333.33

LEGEND

TOP OF CURB ELEVATION FLOW LINE ELEVATION TOP OF SIDEWALK ELEVATION EDGE OF PAVEMENT ELEVATION TOP OF RETAINING WALL ELEVATION GROUND ELEVATION

DRAINAGE SWALE

DRAINAGE DIVIDE

FLOW ARROW

SILT FENCE (PER WDNR TECHNICAL STANDARD 1056)

DITCH CHECK (PER WDNR TECHNICAL STANDARD 1062) TRACKING PAD (PER WDNR TECHNICAL STANDARD 1057) EROSION MAT (PER WDNR TECHNICAL STANDARD 1053) INLET PROTECTION (PER WDNR TECHNICAL STANDARD 1060)

EROSION CONTROL

ALL EROSION CONTROL PRACTICES INDICATED ON THIS PLAN ARE APPROXIMATE LOCATIONS ONLY. THE ACTUAL SITE MAY REQUIRE MORE OR LESS EROSION CONTROL DEPENDING ON THE CURRENT CONDITION OF THE SITE.

- 1. SILT FENCE IS REQUIRED DOWNSLOPE OF ANY DISTURBED LAND THAT MAY CARRY SEDIMENTS OFF SITE.
- 2. A TRACKING PAD IS REQUIRED AT ANY INGRESS/EGRESS LOCATION, WHERE SEDIMENT MAY BE TRACKED OFF-SITE.
- 3. PROPER INLET PROTECTION SHALL BE USED DEPENDING ON THE INLET TYPE.
- 4. ALL NECESSARY SITE DEWATERING SHALL BE PERFORMED IN ACCORDANCE WITH WDNR TECHNICAL STANDARD 1061.




SCALE IN FEET


PRELIMINARY Not for Construction

SHEET NO.

Robert E. Lee & Associates, Inc. ENGINEERING, SURVEYING, ENVIRONMENTAL SERVICES 1250 CENTENNIAL CENTRE BOULEVARD HOBART, WI 54155 920-662-9641 www.releeinc.com

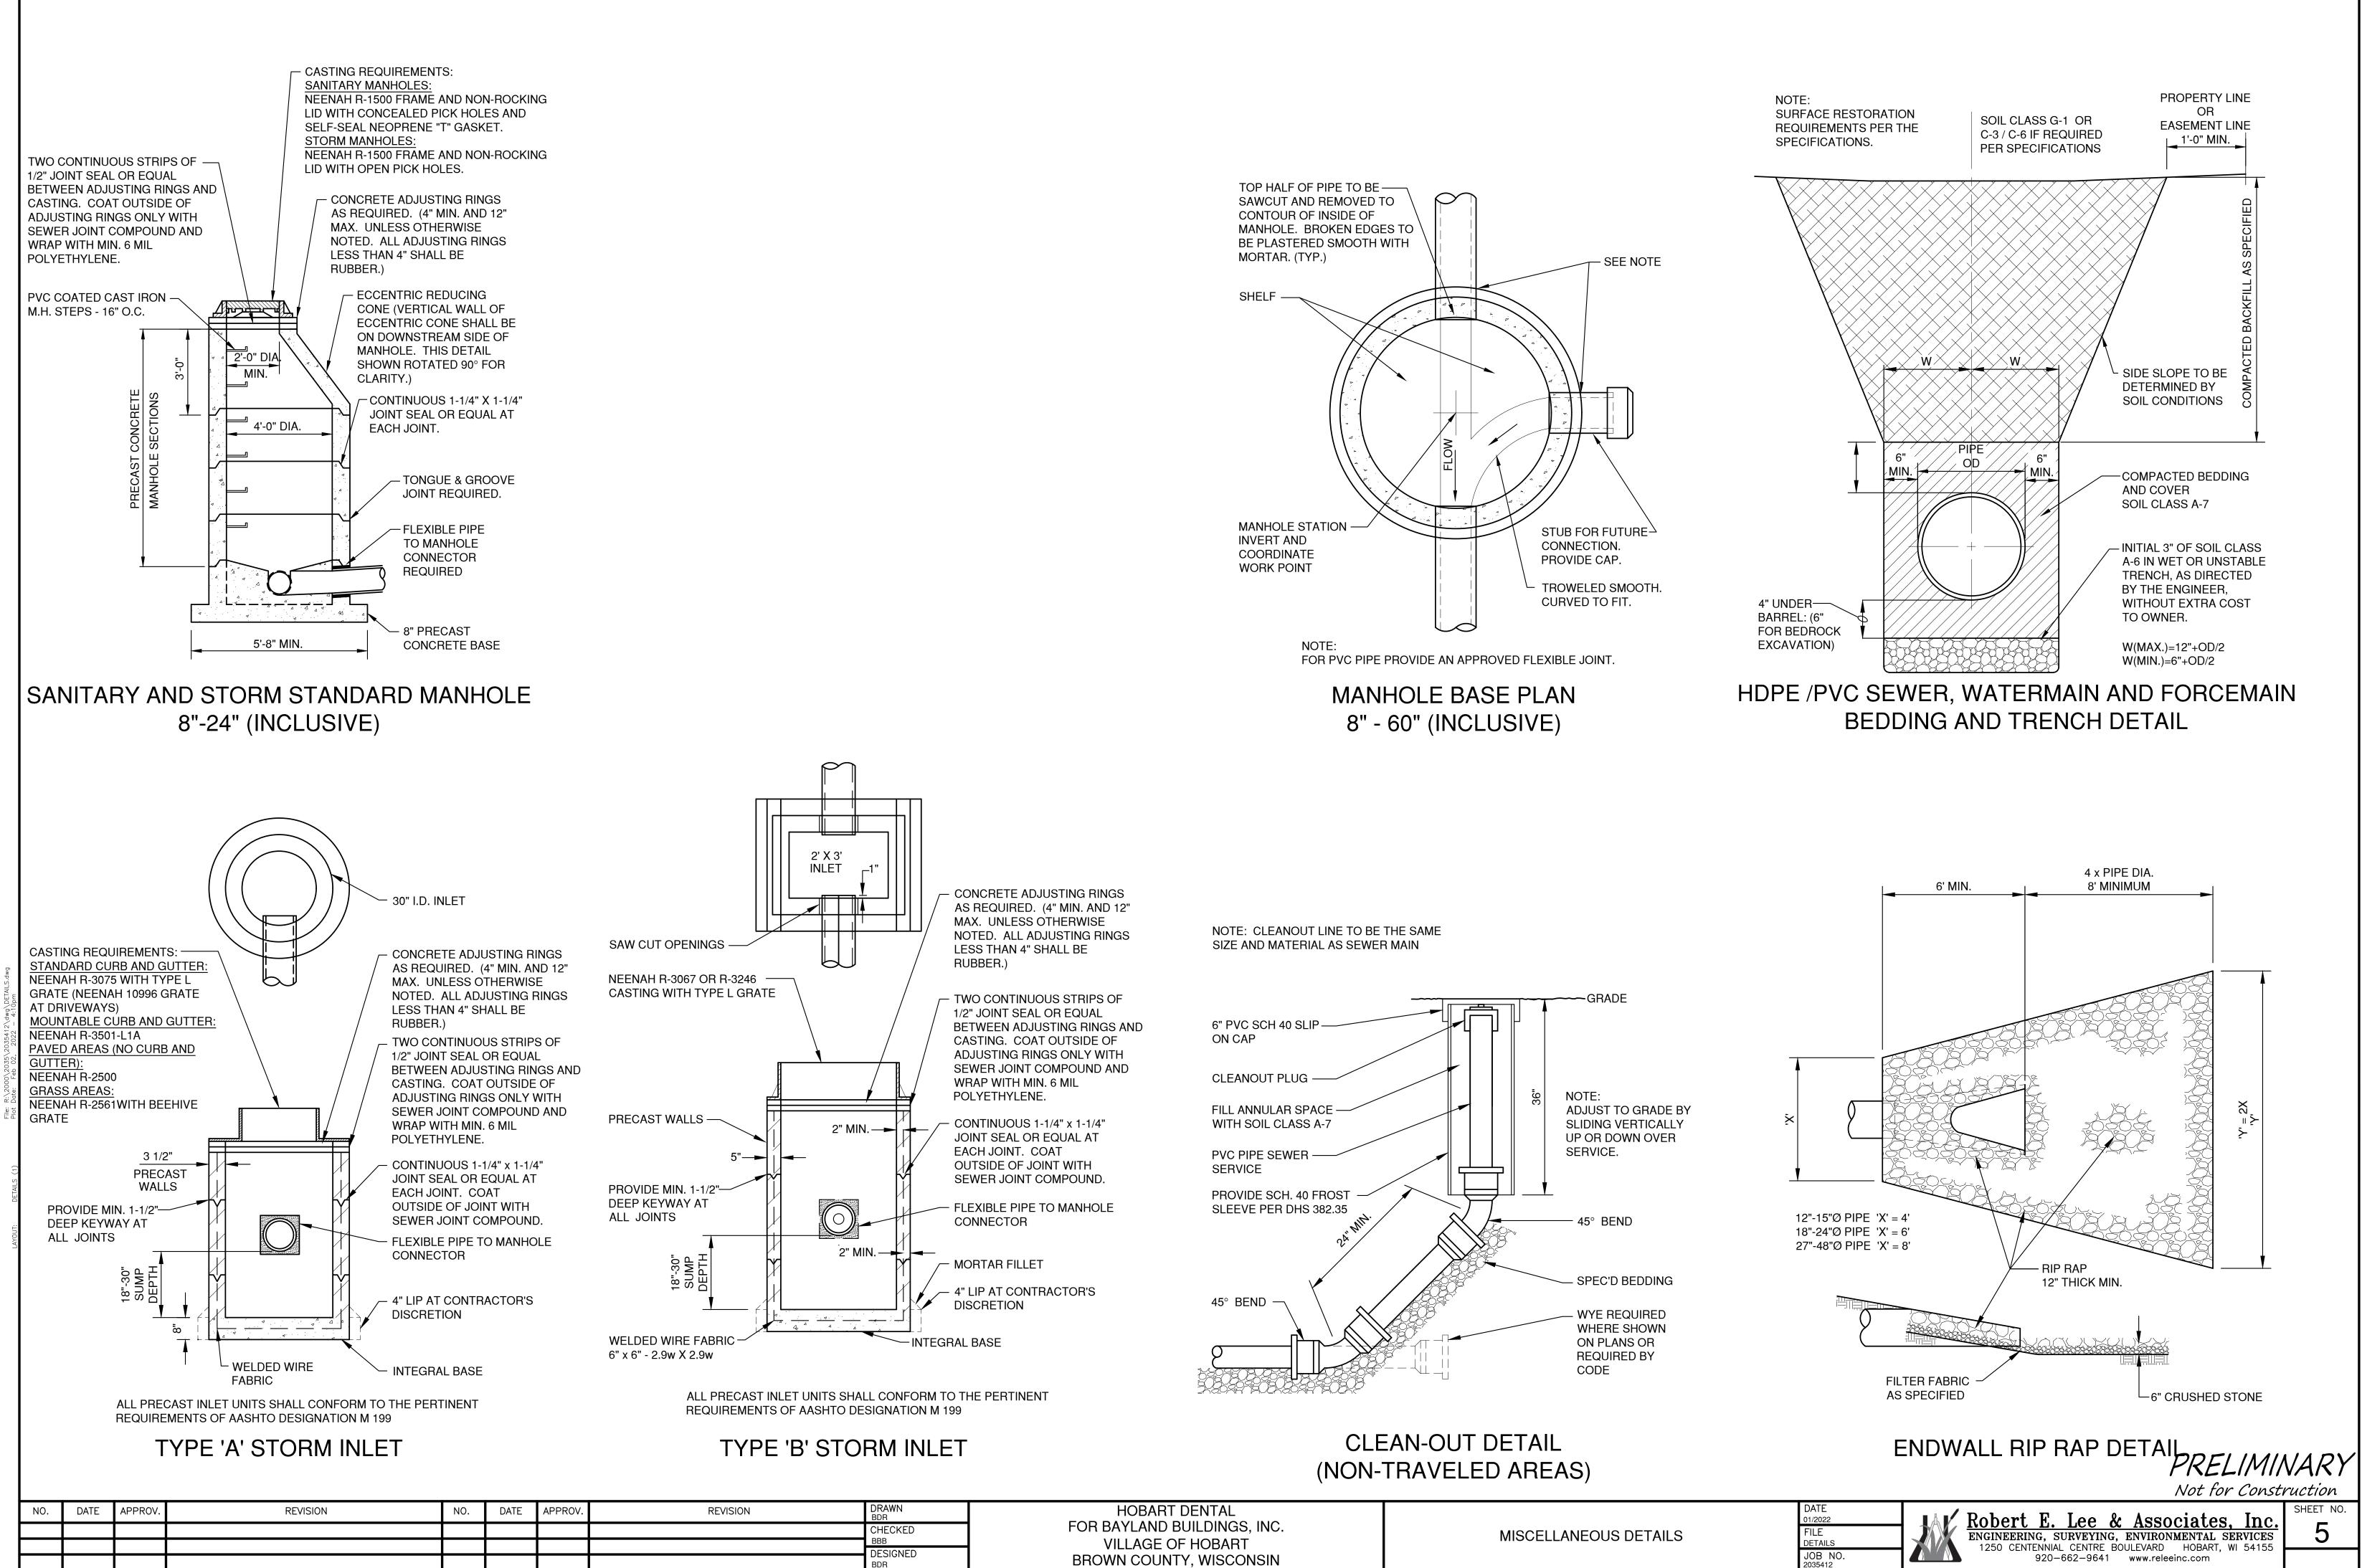


DRAWN BDR	HOBART DENTAL FOR BAYLAND BUILDINGS, INC.	
CHECKED		MISCELLANEOUS DE
BBB DESIGNED	VILLAGE OF HOBART	
BDR	BROWN COUNTY, WISCONSIN	

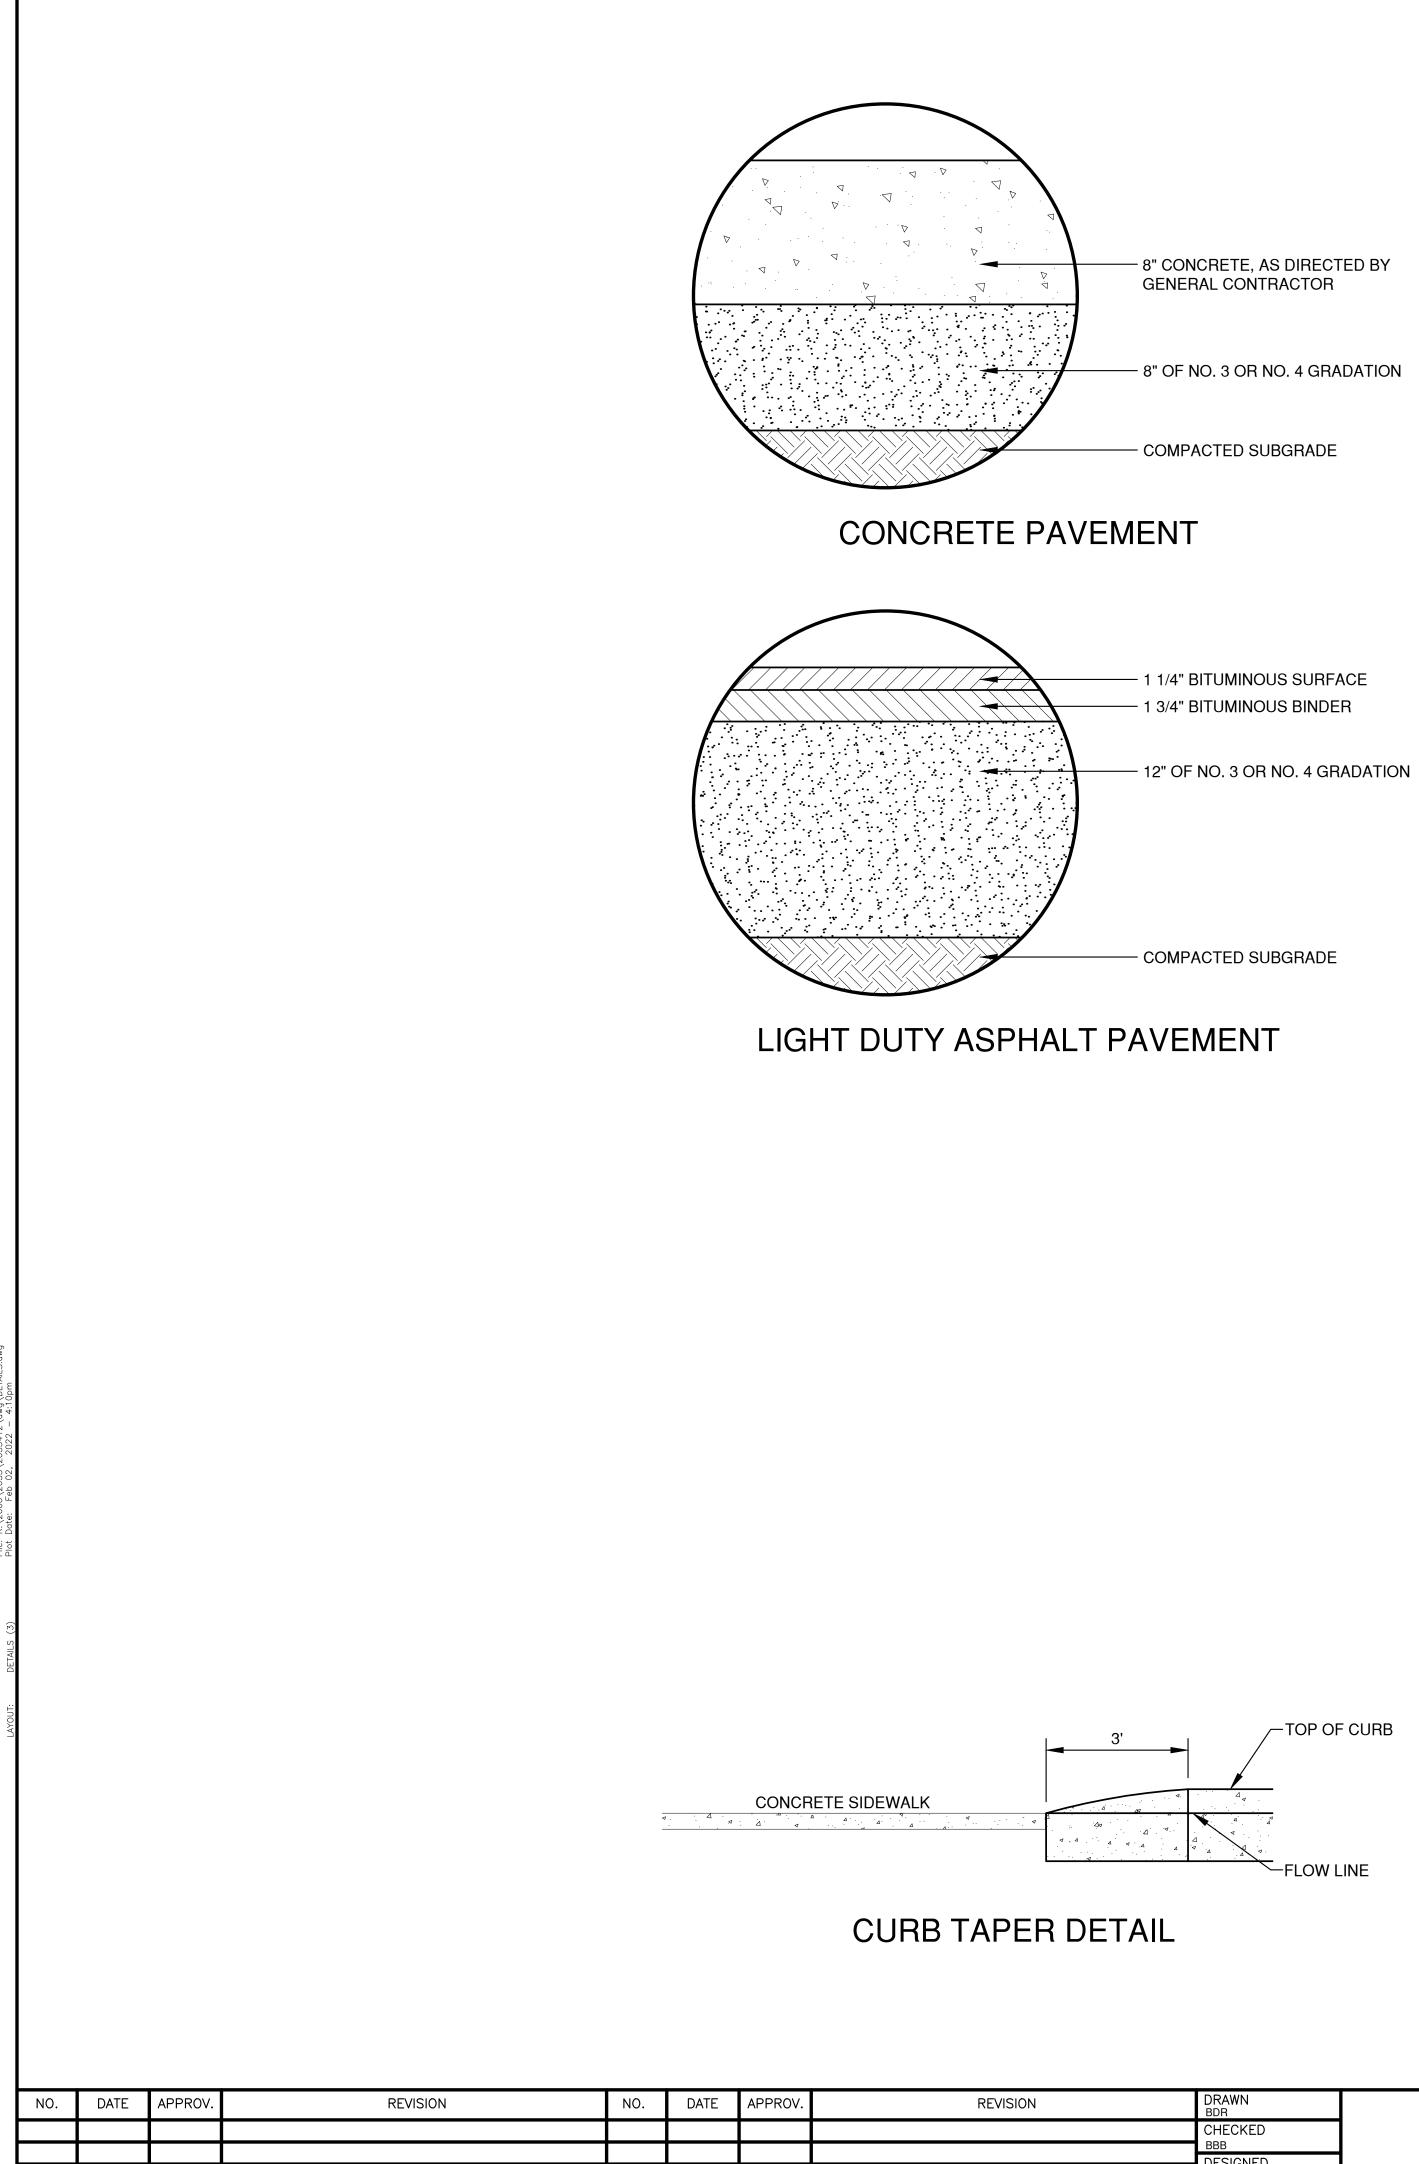


DRAV BDR	WN	HOBART DENTAL	
CHEC	CKED	FOR BAYLAND BUILDINGS, INC.	MISCELLANEOUS DETAILS
BBB	IGNED	VILLAGE OF HOBART	MISOLELANEOUS DE TAIES
BDR	IGNED	BROWN COUNTY, WISCONSIN	

TYPICAL SIDEWALK ADJACENT TO STRUCTURE

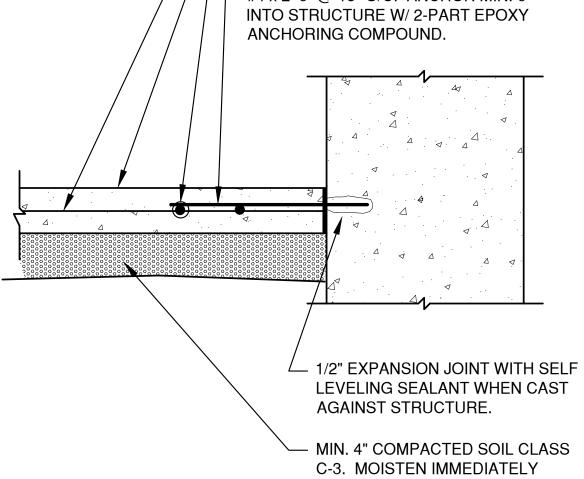

- EXISTING GUTTER PAN.
- NOTES:

3" MININ AGGREGAT

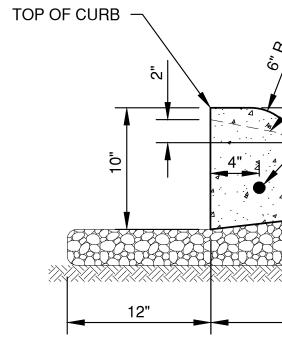

- 8" OF NO. 3 OR NO. 4 GRADATION

	CURB CUT AT DRIVEWAY
	(2) #4 CONTINUOUS WHERE REQUIRED
m Pr	BROOM FINISH
4% SLOPE	/
18"	
UNDISTURBED SOIL	
MUM COMPACTED CRUSHI TE BASE COURSE MATERIA GRADATION NO	AL,

1. PROVIDE 1" EXPANSION JOINTS AT 300' INTERVALS OR AS SPECIFIED. PROVIDE CONTRACTION JOINTS EVERY 30' OR AS DIRECTED.

2. AT REMOVAL AND REPLACEMENT AREAS AND AT TIE-INS TO EXISTING CURB AND GUTTER, PROVIDE (2) #4 BARS, 18" LONG. DRILL AND GROUT INTO EXISTING CURB AND GUTTER 9". MATCH EXISTING SLOPE OF

MOUNTABLE CURB AND GUTTER

6"x6"-W2 x W2 WWF CENTER IN SLAB

── #4 x 2'-6" @ 18" O/C. ANCHOR MIN. 6"

LEVELING SEALANT WHEN CAST


BEFORE PLACING CONCRETE

	Not for Consti	ruction	
DATE 01/2022 FILE DETAILS	Robert E. Lee & Associates, Inc. ENGINEERING, SURVEYING, ENVIRONMENTAL SERVICES 1250 CENTENNIAL CENTRE BOULEVARD HOBART, WI 54155	SHEET NO.	
JOB NO. 2035412	920-662-9641 www.releeinc.com		

PRELIMINARY

NO.	DATE	APPROV.	REVISION	NO.	DATE	APPROV.	REVISION



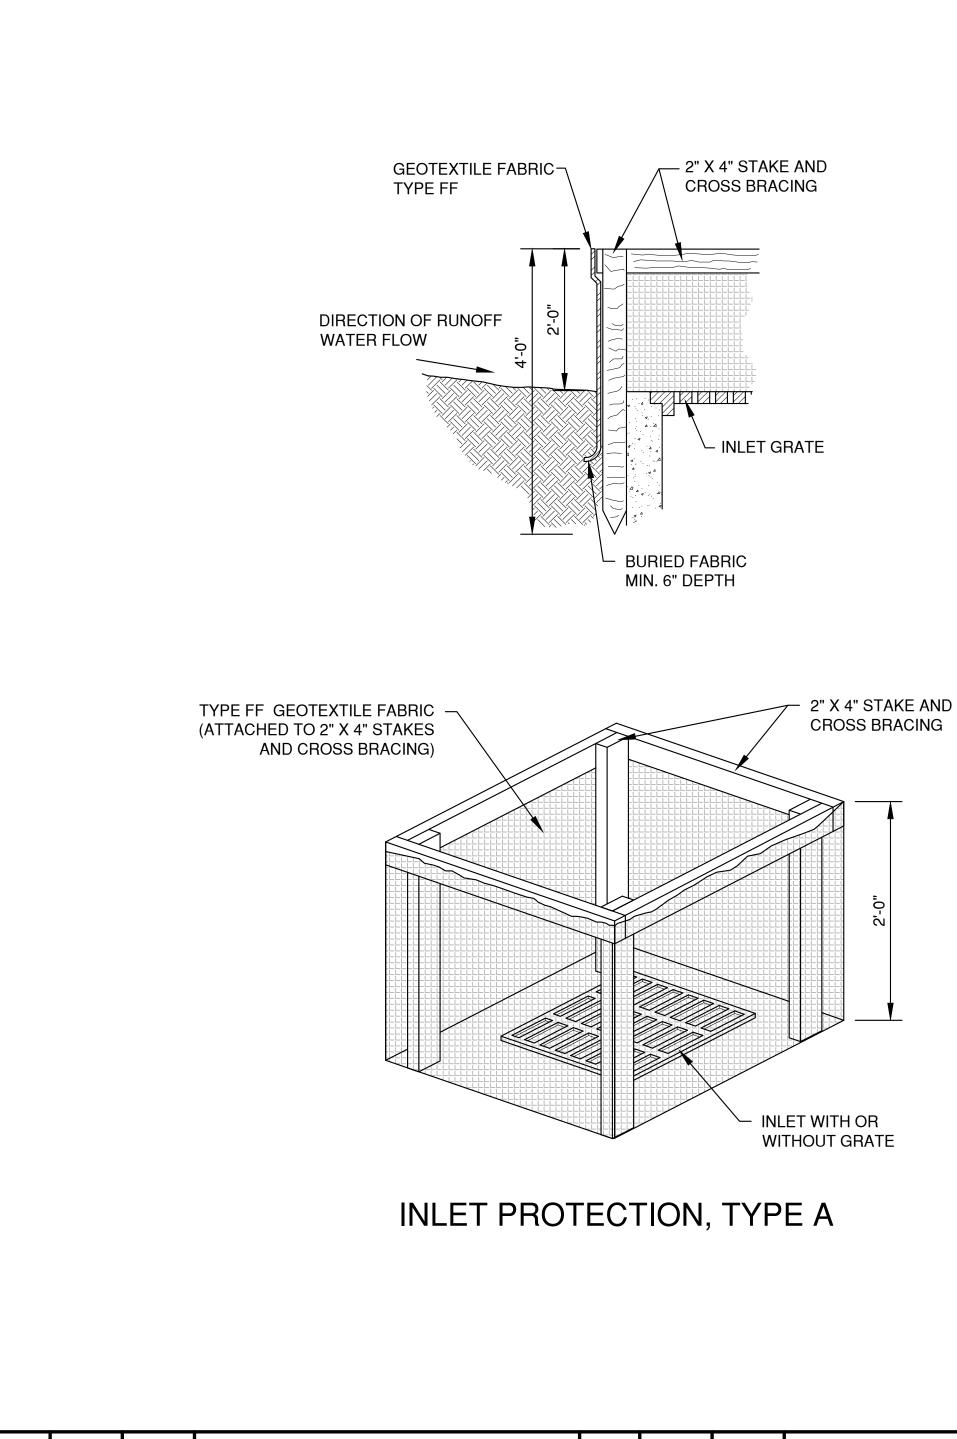

INLET PROTECTION NOTES:

INLET PROTECTION DEVICES SHALL BE IN ACCORDANCE WITH WDNR TECHNICAL STANDARD 1060, STORM DRAIN INLET PROTECTION FOR CONSTRUCTION SITES.

MANUFACTURED ALTERNATIVES APPROVED AND LISTED ON THE WDOT PRODUCT ACCEPTABILITY LIST MAY BE SUBSTITUTED.

WHEN REMOVING OR MAINTAINING INLET PROTECTION, CARE SHALL BE TAKEN SO THAT THE SEDIMENT TRAPPED ON THE GEOTEXTILE FABRIC DOES NOT FALL INTO THE INLET. ANY MATERIAL FALLING INTO THE INLET SHALL BE REMOVED IMMEDIATELY.

MAINTENANCE NOTES:

WHEN REMOVING OR MAINTAINING INLET PROTECTION, CARE SHALL BE TAKEN SO THAT THE SEDIMENT TRAPPED IN THE FABRIC DOES NOT FALL INTO THE STRUCTURE. MATERIAL THAT HAS FALLEN INTO THE INLET SHALL BE IMMEDIATELY REMOVED.

INSTALLATION NOTES: TYPE "B" AND "C"

TRIM EXCESS FABRIC IN THE FLOW LINE TO WITHIN 3" OF THE GRATE.

DEMONSTRATE A METHOD OF MAINTENANCE, USING A SEWN FLAP, HAND HOLDS OR OTHER METHOD TO PREVENT ACCUMULATED SEDIMENT FROM ENTERING THE INLET.

TYPE "D"

DO NOT INSTALL INLET PROTECTION TYPE D IN INLETS SHALLOWER THAN 30" MEASURED FROM THE BOTTOM OF THE INLET TO THE TOP OF THE GRATE.

TRIM EXCESS FABRIC IN THE FLOW LINE TO WITHIN 3" OF THE GRATE.

THE INSTALLED BAG SHALL HAVE A MINIMUM SIDE CLEARANCE, BETWEEN THE INLET WALLS AND THE BAG, MEASURED AT THE BOTTOM OF THE OVERFLOW HOLES, OF 3". WHERE NECESSARY, CINCH THE BAG, USING PLASTIC ZIP TIES, TO ACHIEVE THE 3" CLEARANCE, THE TIES SHALL BE PLACED AT THE MAXIMUM OF 4" FROM THE BOTTOM OF THE BAG.

TYPE FF GEOTEXTILE FABRIC (EXTEND FABRIC A MINIMUM OF **10" AROUND GRATE PERIMETER** FOR MAINTENANCE OR REMOVAL)

> SIDE FLAP SEE NOTE 4

LENGTH AND WIDTH DIMENSIONS SHALL BE PER PLAN

FRONT LIFTING FLAP **SEE NOTE 3**


MINIMUM DOUBLE STITCHED SEAMS ALL AROUND SIDE PIECES AND ON FLAP POCKETS.

> TYPE FF GEOTEXTILE FABRIC (FRONT, BACK, AND BOTTOM TO **BE A SINGLE PIECE OF FF FABRIC**

4" X 6" OPENINGS WITH ROUNDED CORNERS SHALL BE HEAT CUT (ONE HOLE ON EACH OF THE FOUR SIDES)

DRAWN BDR	HOBART DENTAL	
CHECKED	FOR BAYLAND BUILDINGS, INC.	EROSION CONTR
BBB	VILLAGE OF HOBART	INLET PROTECTION TYPES
DESIGNED BDR	BROWN COUNTY, WISCONSIN	

INLET PROTECTION, TYPE B (WITHOUT CURB BOX) (CAN BE INSTALLED IN ANY INLET WITHOUT A CURB BOX)

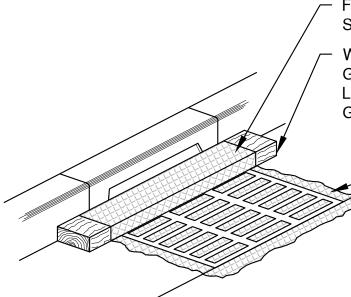

- FLAP POCKET SEE NOTE 5


- WOOD 2" X 4" EXTENDS 8" BEYOND GRATE WIDTH ON BOTH SIDES, LENGTH VARIES. SECURE TO GRATE WITH PLASTIC TIES.

> TYPE FF GEOTEXTILE FABRIC (EXTEND FABRIC A MINIMUM OF **10" AROUND GRATE PERIMETER** FOR MAINTENANCE OR REMOVAL)

INLET PROTECTION, TYPE C (WITH CURB BOX)

NOTES:


- TAPER BOTTOM OF BAG TO MAINTAIN THREE INCHES OF CLEARANCE 1. BETWEEN THE BAG AND THE STRUCTURE, MEASURED FROM THE BOTTOM OF THE OVERFLOW OPENINGS TO THE STRUCTURE WALL.
- GEOTEXTILE FABRIC TYPE FF FOR FLAPS, TOP AND BOTTOM OF THE 2. OUTSIDE OF FILTER BAG. FRONT, BACK AND BOTTOM OF FILTER BAG BEING ONE PIECE.
- FRONT LIFTING FLAP IS TO BE USED WHEN REMOVING AND MAINTAINING 3. FILTER BAG.
- 4. SIDE FLAPS SHALL BE A MAXIMUM OF TWO INCHES LONG. FOLD THE FABRIC OVER AND REINFORCE WITH MULTIPLE STITCHES.
- FLAP POCKETS SHALL BE LARGE ENOUGH TO ACCEPT WOOD 2" X 4". THE 5. REBAR, STEEL PIPE, OR WOOD SHALL BE INSTALLED IN THE REAR FLAP AND SHALL NOT BLOCK THE TOP HALF OF THE CURB FACE OPENING.

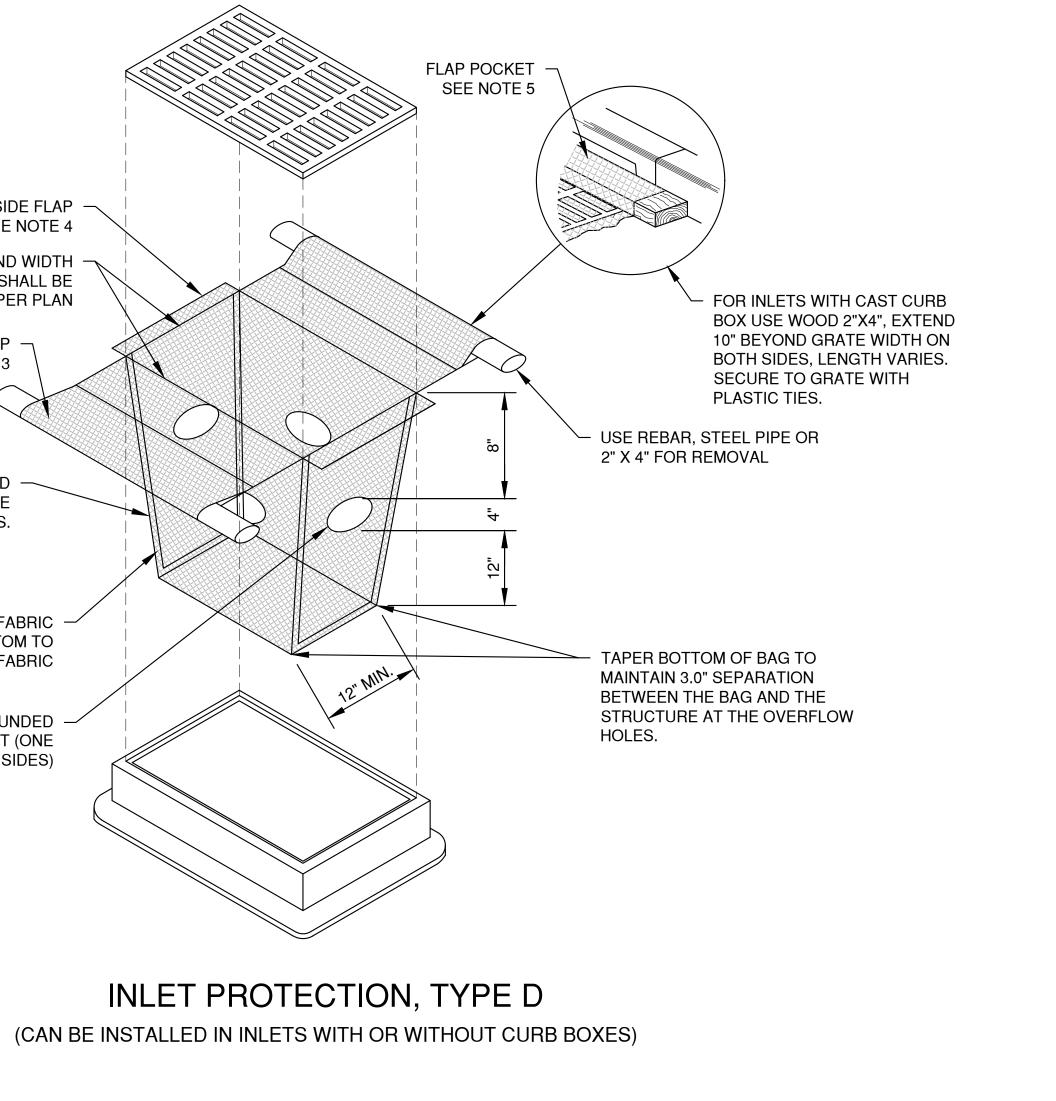

	DATE 01/2022 FILE	Robert E. Lee & Associates, Inc. ENGINEERING, SURVEYING, ENVIRONMENTAL SERVICES	SHEET NO.
S A, B, C AND D	EROSION CONTROL JOB NO.	1250 CENTENNIAL CENTRE BOULEVARD HOBART, WI 54155	
	JOB NO. 2025412	920-662-9641 www.releeinc.com	

NOTES:


- 1. BETWEEN THE BAG AND THE STRUCTURE, MEASURED FROM THE BOTTOM OF THE OVERFLOW OPENINGS TO THE STRUCTURE WALL.
- 2. GEOTEXTILE FABRIC TYPE HR FOR BOTTOM HALF OF FILTER BAG. FRONT, BACK AND BOTTOM OF FILTER BAG BEING ONE PIECE.
- 3. FRONT LIFTING FLAP IS TO BE USED WHEN REMOVING AND MAINTAINING FILTER BAG.
- SIDE FLAPS SHALL BE A MAXIMUM OF TWO INCHES LONG. FOLD THE FABRIC 4. OVER AND REINFORCE WITH MULTIPLE STITCHES.
- FLAP POCKETS SHALL BE LARGE ENOUGH TO ACCEPT WOOD 2" X 4". THE 5. REBAR, STEEL PIPE, OR WOOD SHALL BE INSTALLED IN THE REAR FLAP AND SHALL NOT BLOCK THE TOP HALF OF THE CURB FACE OPENING.

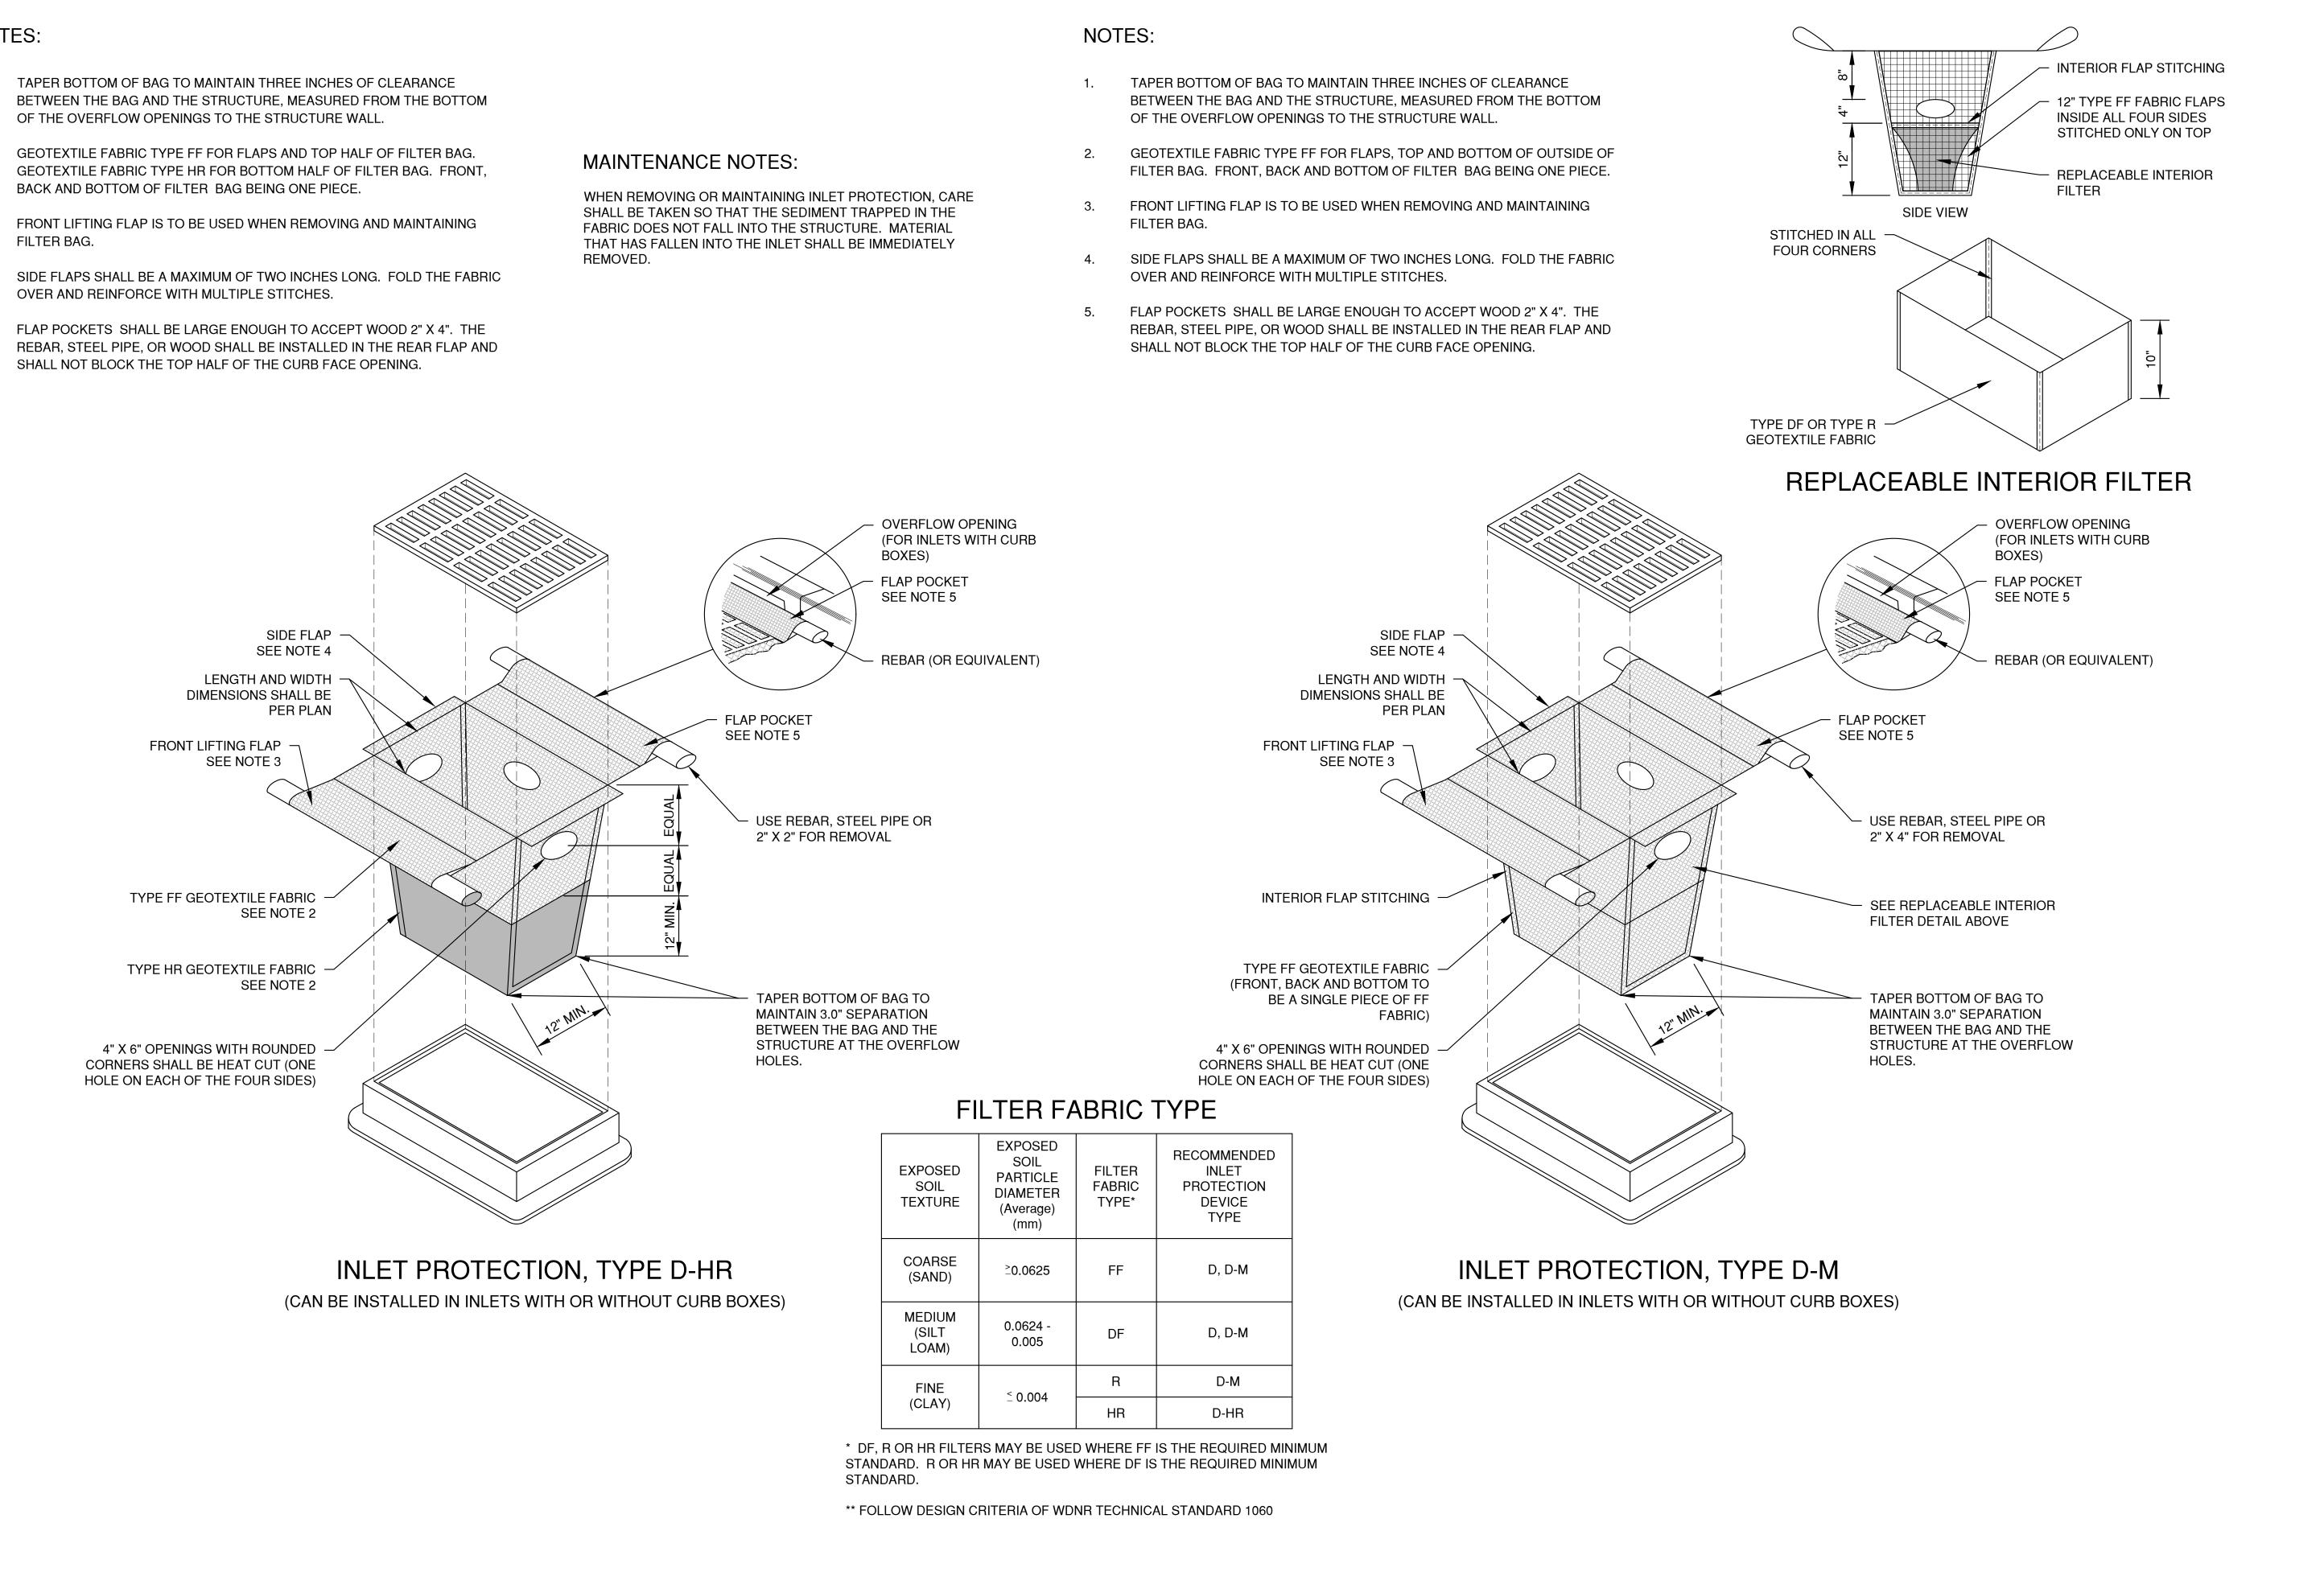

		-			-		
NO.	DATE	APPROV.	REVISION	NO.	DATE	APPROV.	REVISION


DRAWN BDR HOBART DENTAL **EROSION CONTR** FOR BAYLAND BUILDINGS, INC. CHECKED INLET PROTECT VILLAGE OF HOBART TYPE D-HR AND TYP DESIGNED **BROWN COUNTY, WISCONSIN**

DATE01/2022ONPE D-MJOB NO. 2035412	Robert E. Lee & Associates, Inc. ENGINEERING, SURVEYING, ENVIRONMENTAL SERVICES 1250 CENTENNIAL CENTRE BOULEVARD HOBART, WI 54155 920-662-9641 www.releeinc.com	SHEET NO.
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HOBART DENTAL FOR BAYLAND BUILDINGS, INC. VILLAGE OF HOBART	EROSION CONTROL SHEET FLOW DETAILS	DATE 01/2022 FILE EROSION CONTROL	Robert E. Lee & Associates, Inc. ENGINEERING, SURVEYING, ENVIRONMENTAL SERVICES 1250 CENTENNIAL CENTRE BOULEVARD HOBART, WI 54155	SHEET NO.
BROWN COUNTY, WISCONSIN		JOB NO. 2035412	920-662-9641 www.releeinc.com	

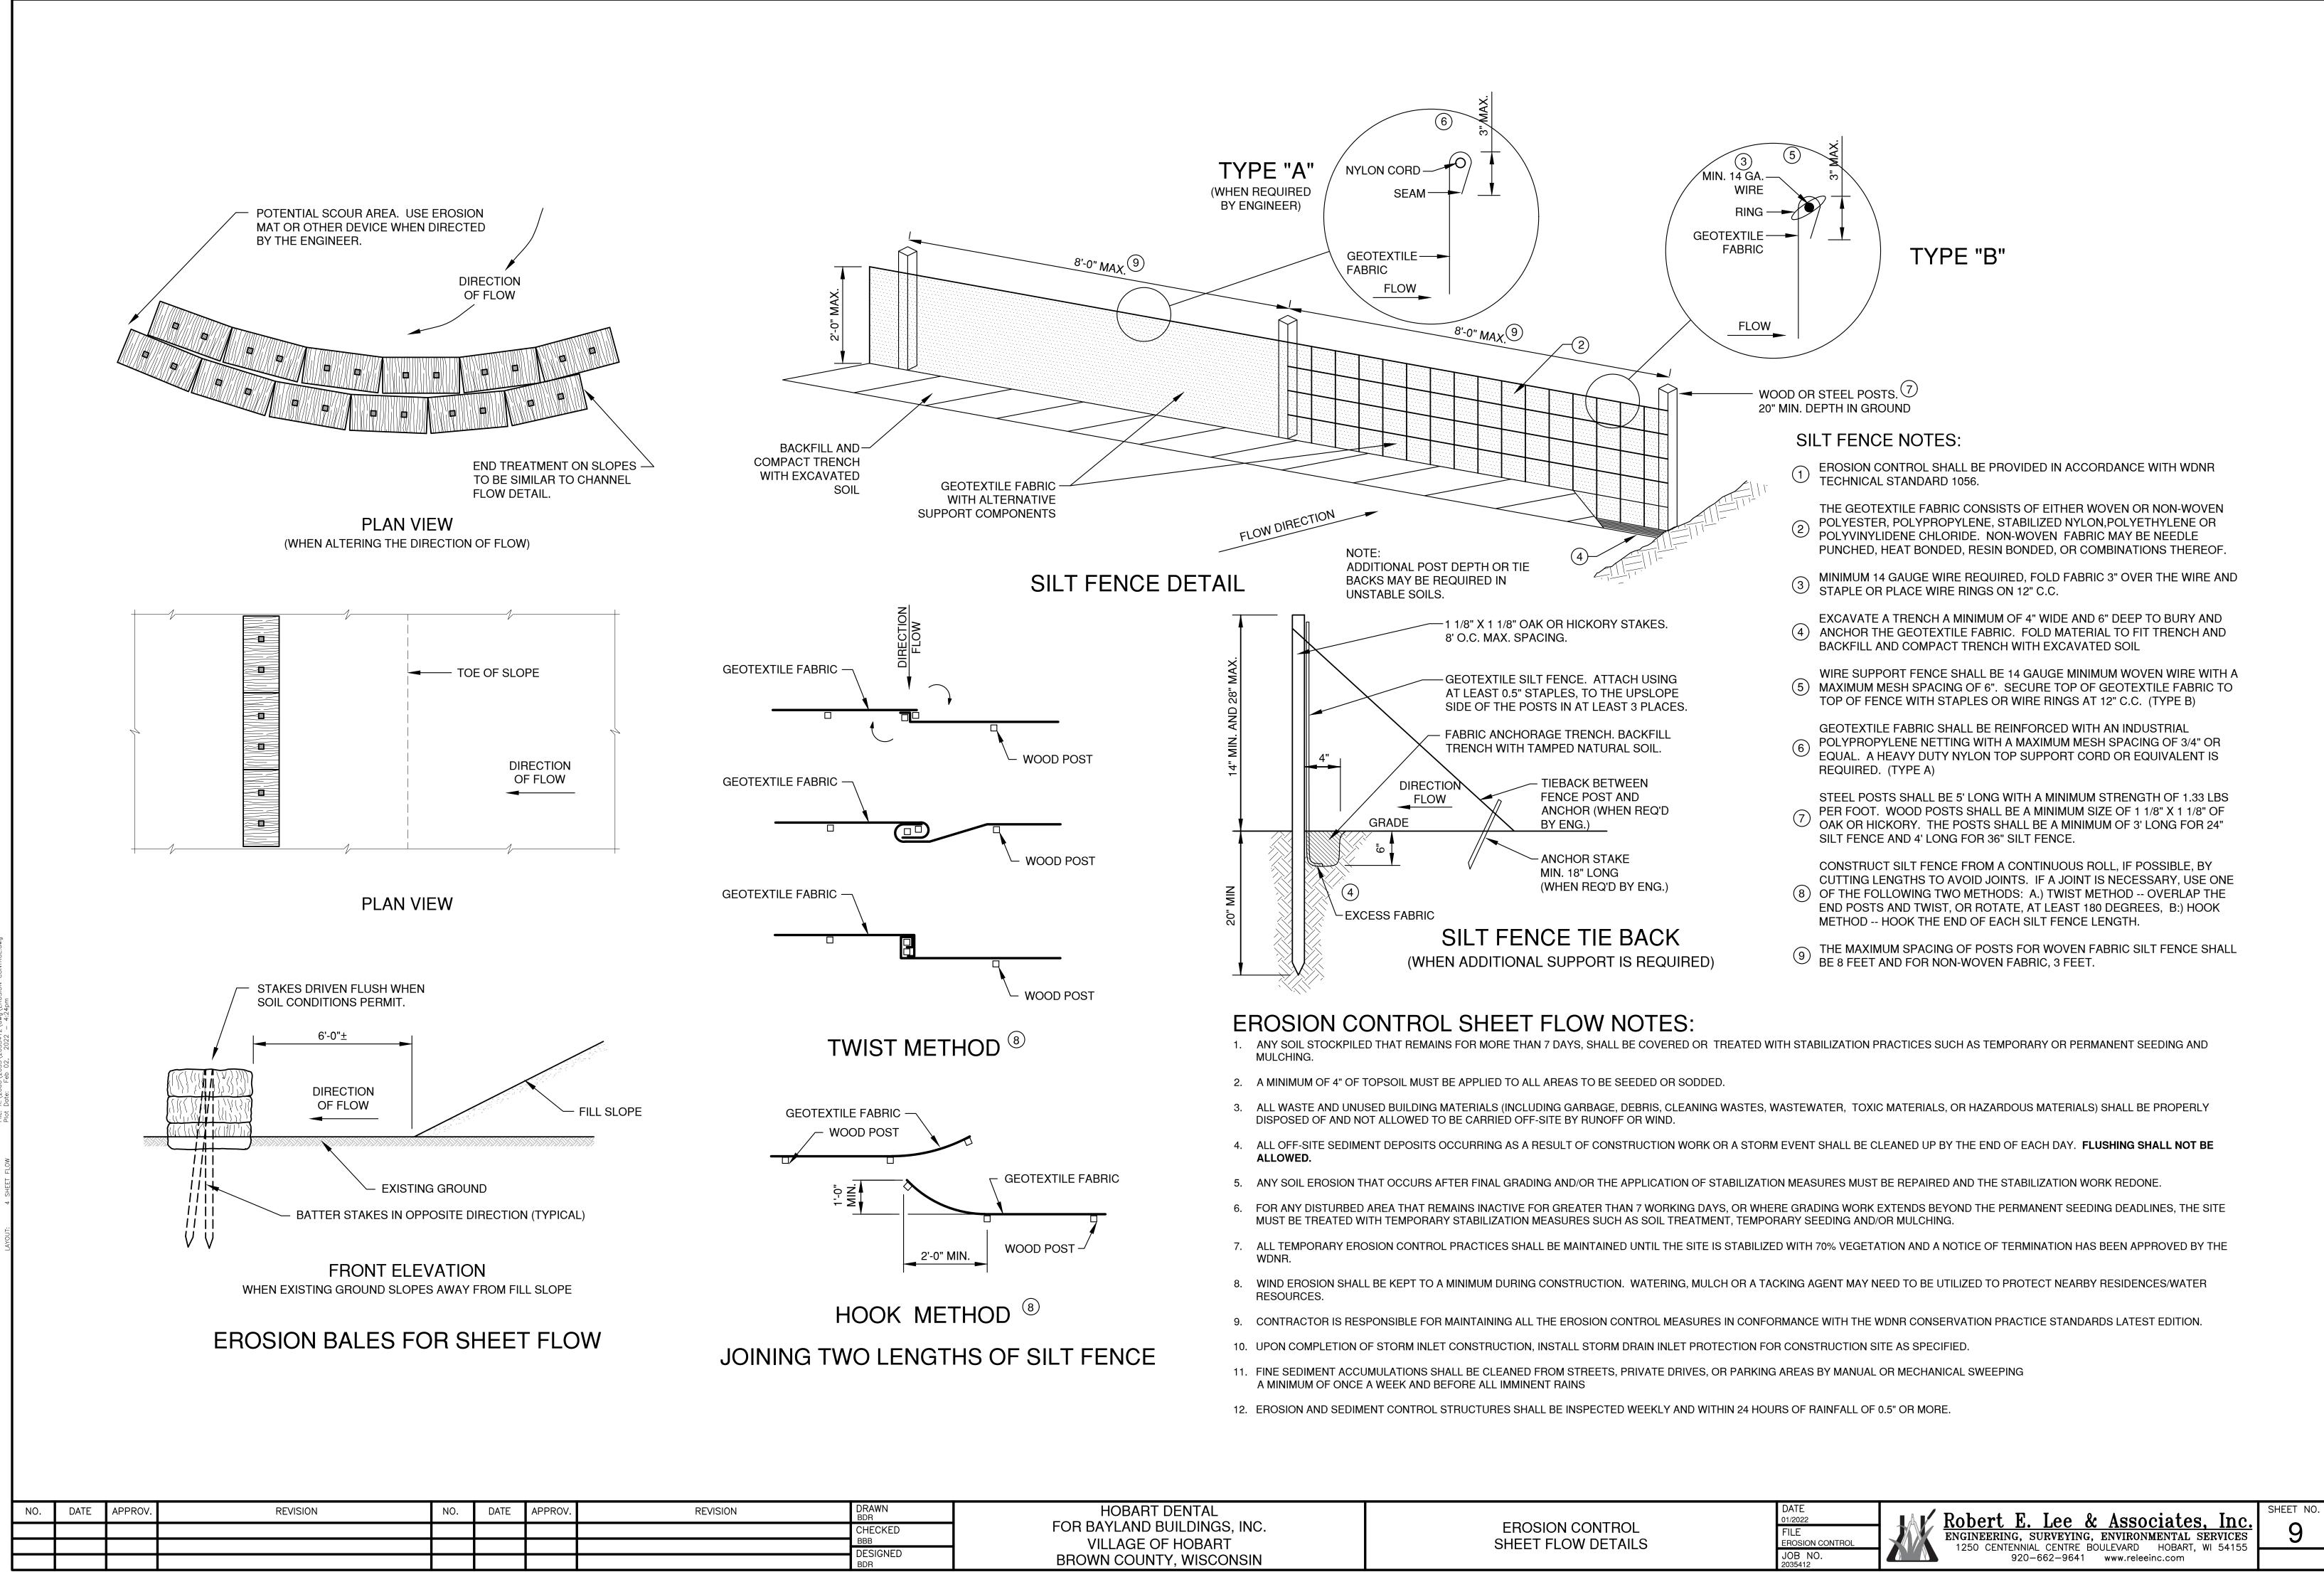

- 6. IF MINIMUM INSTALLATION LENGTH IS NOT POSSIBLE DUE TO SITE GEOMETRY, INSTALL THE MAXIMUM LENGTH PRACTICABLE AND SUPPLEMENT WITH ADDITIONAL PRACTICES AS NEEDED.
- 7. ACCOMMODATE EXITING VEHICLES IN EXCESS OF MANUFACTURED TRACKOUT CONTROL DEVICE WEIGHT CAPACITY WITH OTHER TREATMENT PRACTICES.

MANUFACTURED TRACKOUT CONTROL DETAIL

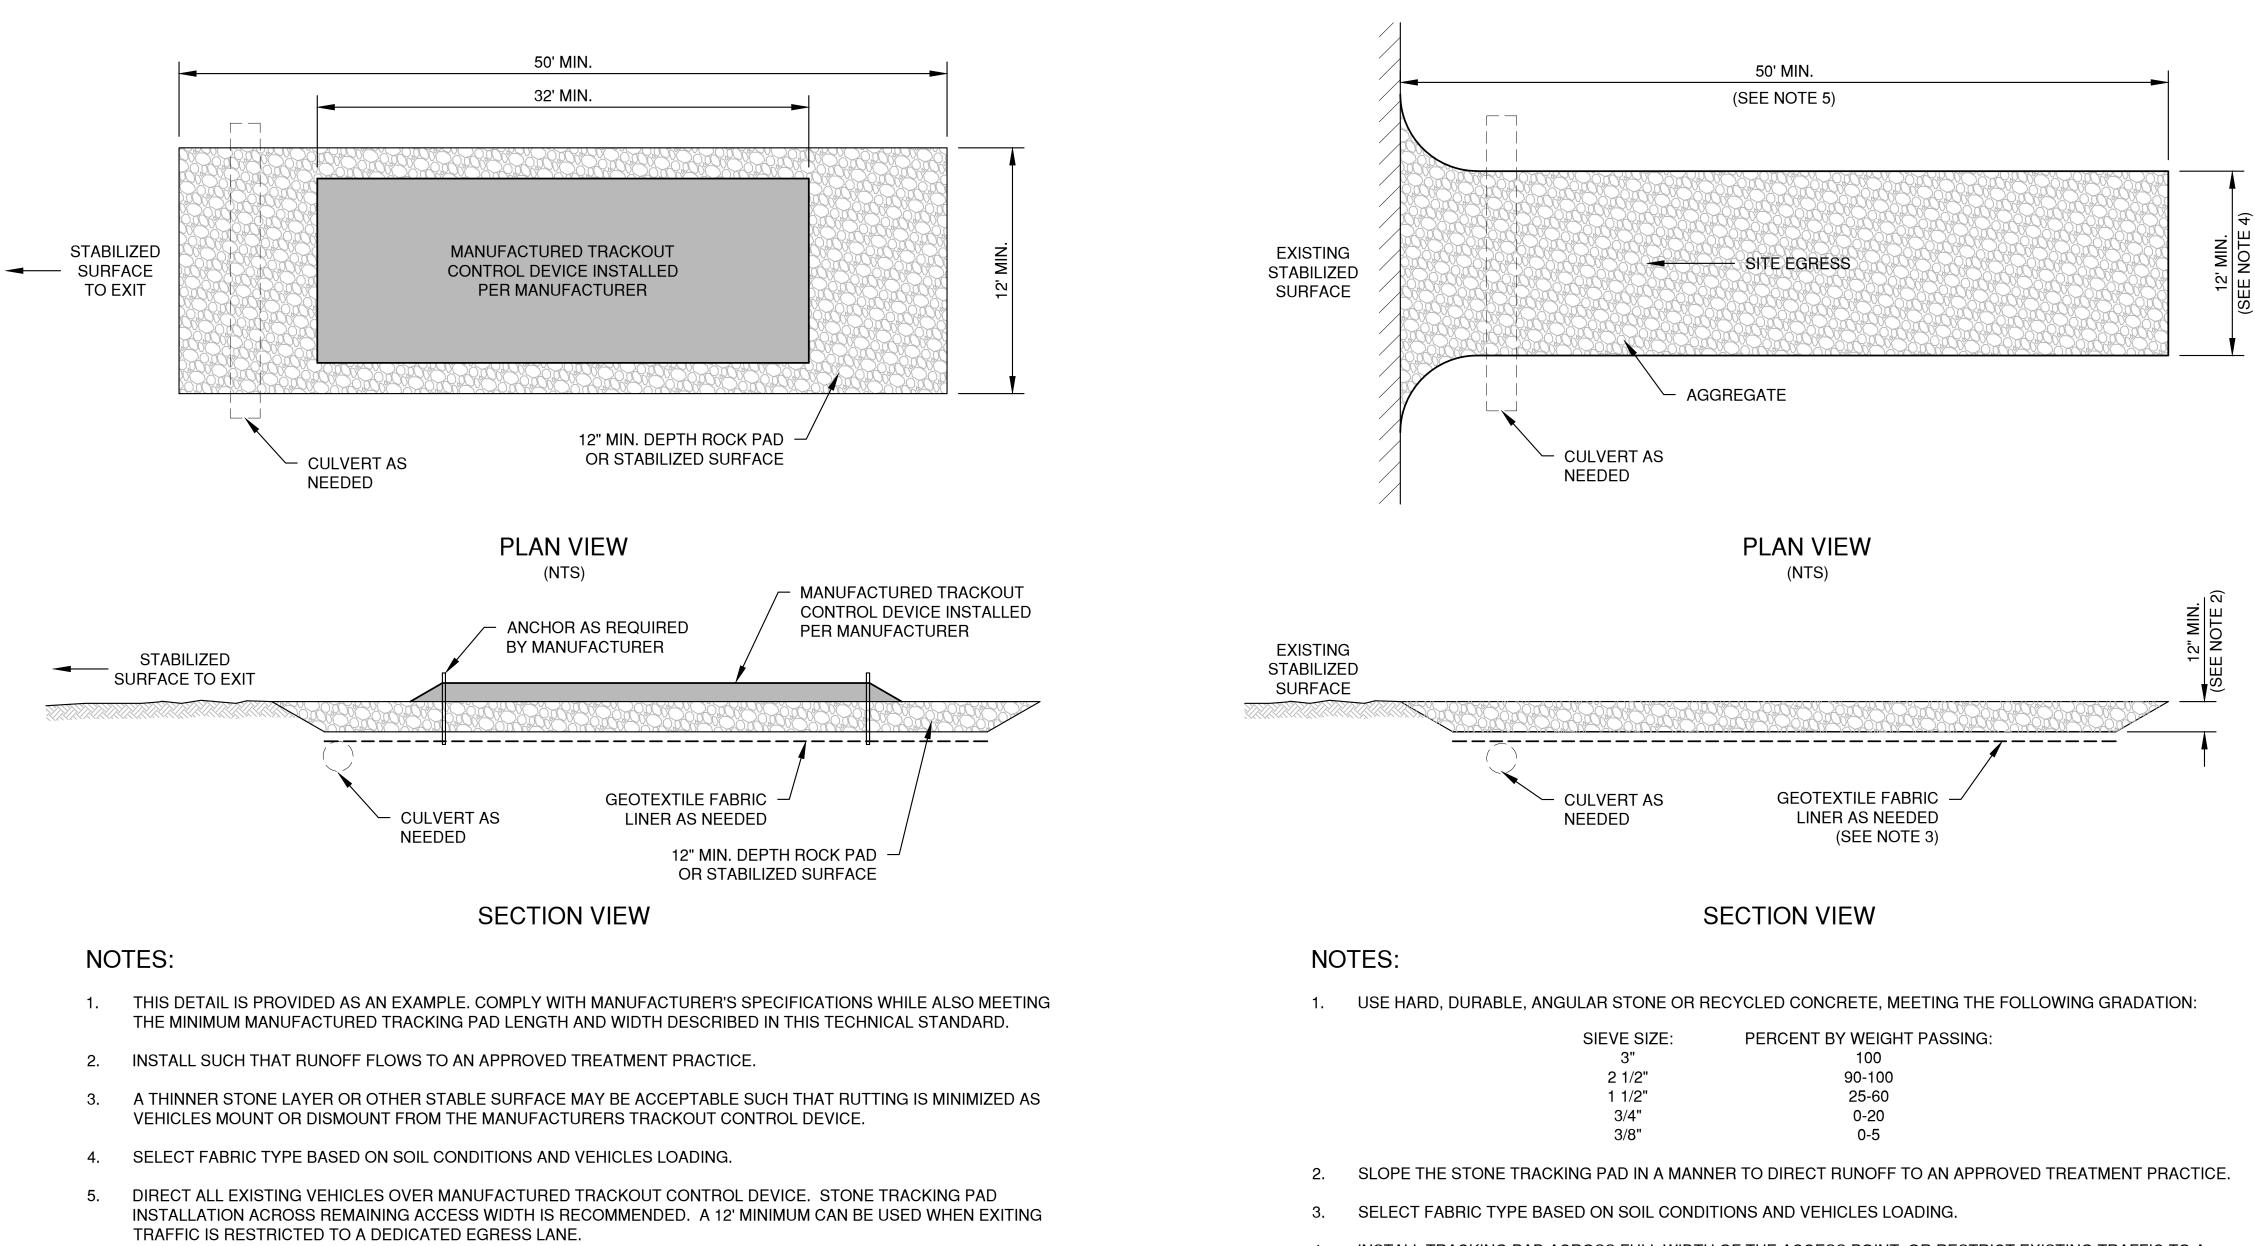NO.	DATE	APPROV.	REVISION	NO.	DATE	APPROV.	REVISION	DRAWN BDR	HOBART DENTAL	
								CHECKED	FOR BAYLAND BUILDINGS, INC.	
								DESIGNED		TRACKOUT CONTROL PR
								BDR	BROWN COUNTY, WISCONSIN	

* TRACKOUT CONTROL TO BE PROVIDED PER DETAILS BELOW AND IN ACCORDANCE WITH WDNR TECHNICAL STANDARD 1057




4. INSTALL TRACKING PAD ACROSS FULL WIDTH OF THE ACCESS POINT, OR RESTRICT EXISTING TRAFFIC TO A DEDICATED EGRESS LANE AT LEAST 12 FEET WIDE ACROSS THE TOP OF THE PAD.

5. IF A 50' PAD LENGTH IS NOT POSSIBLE DUE TO SITE GEOMETRY, INSTALL THE MAXIMUM LENGTH PRACTICABLE AND

STONE TRACKING PAD DETAIL

2035412	ROL FIL PRACTICES ERC JOE	V2022 LE ROSION CONTROL DB NO.		Associates, Inc. , ENVIRONMENTAL SERVICES OULEVARD HOBART, WI 54155 www.releeinc.com	SHEET NO.
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2 /A1.0 SCALE = 3/16" = 1'-0" BASEMENT FLOOR PLAN

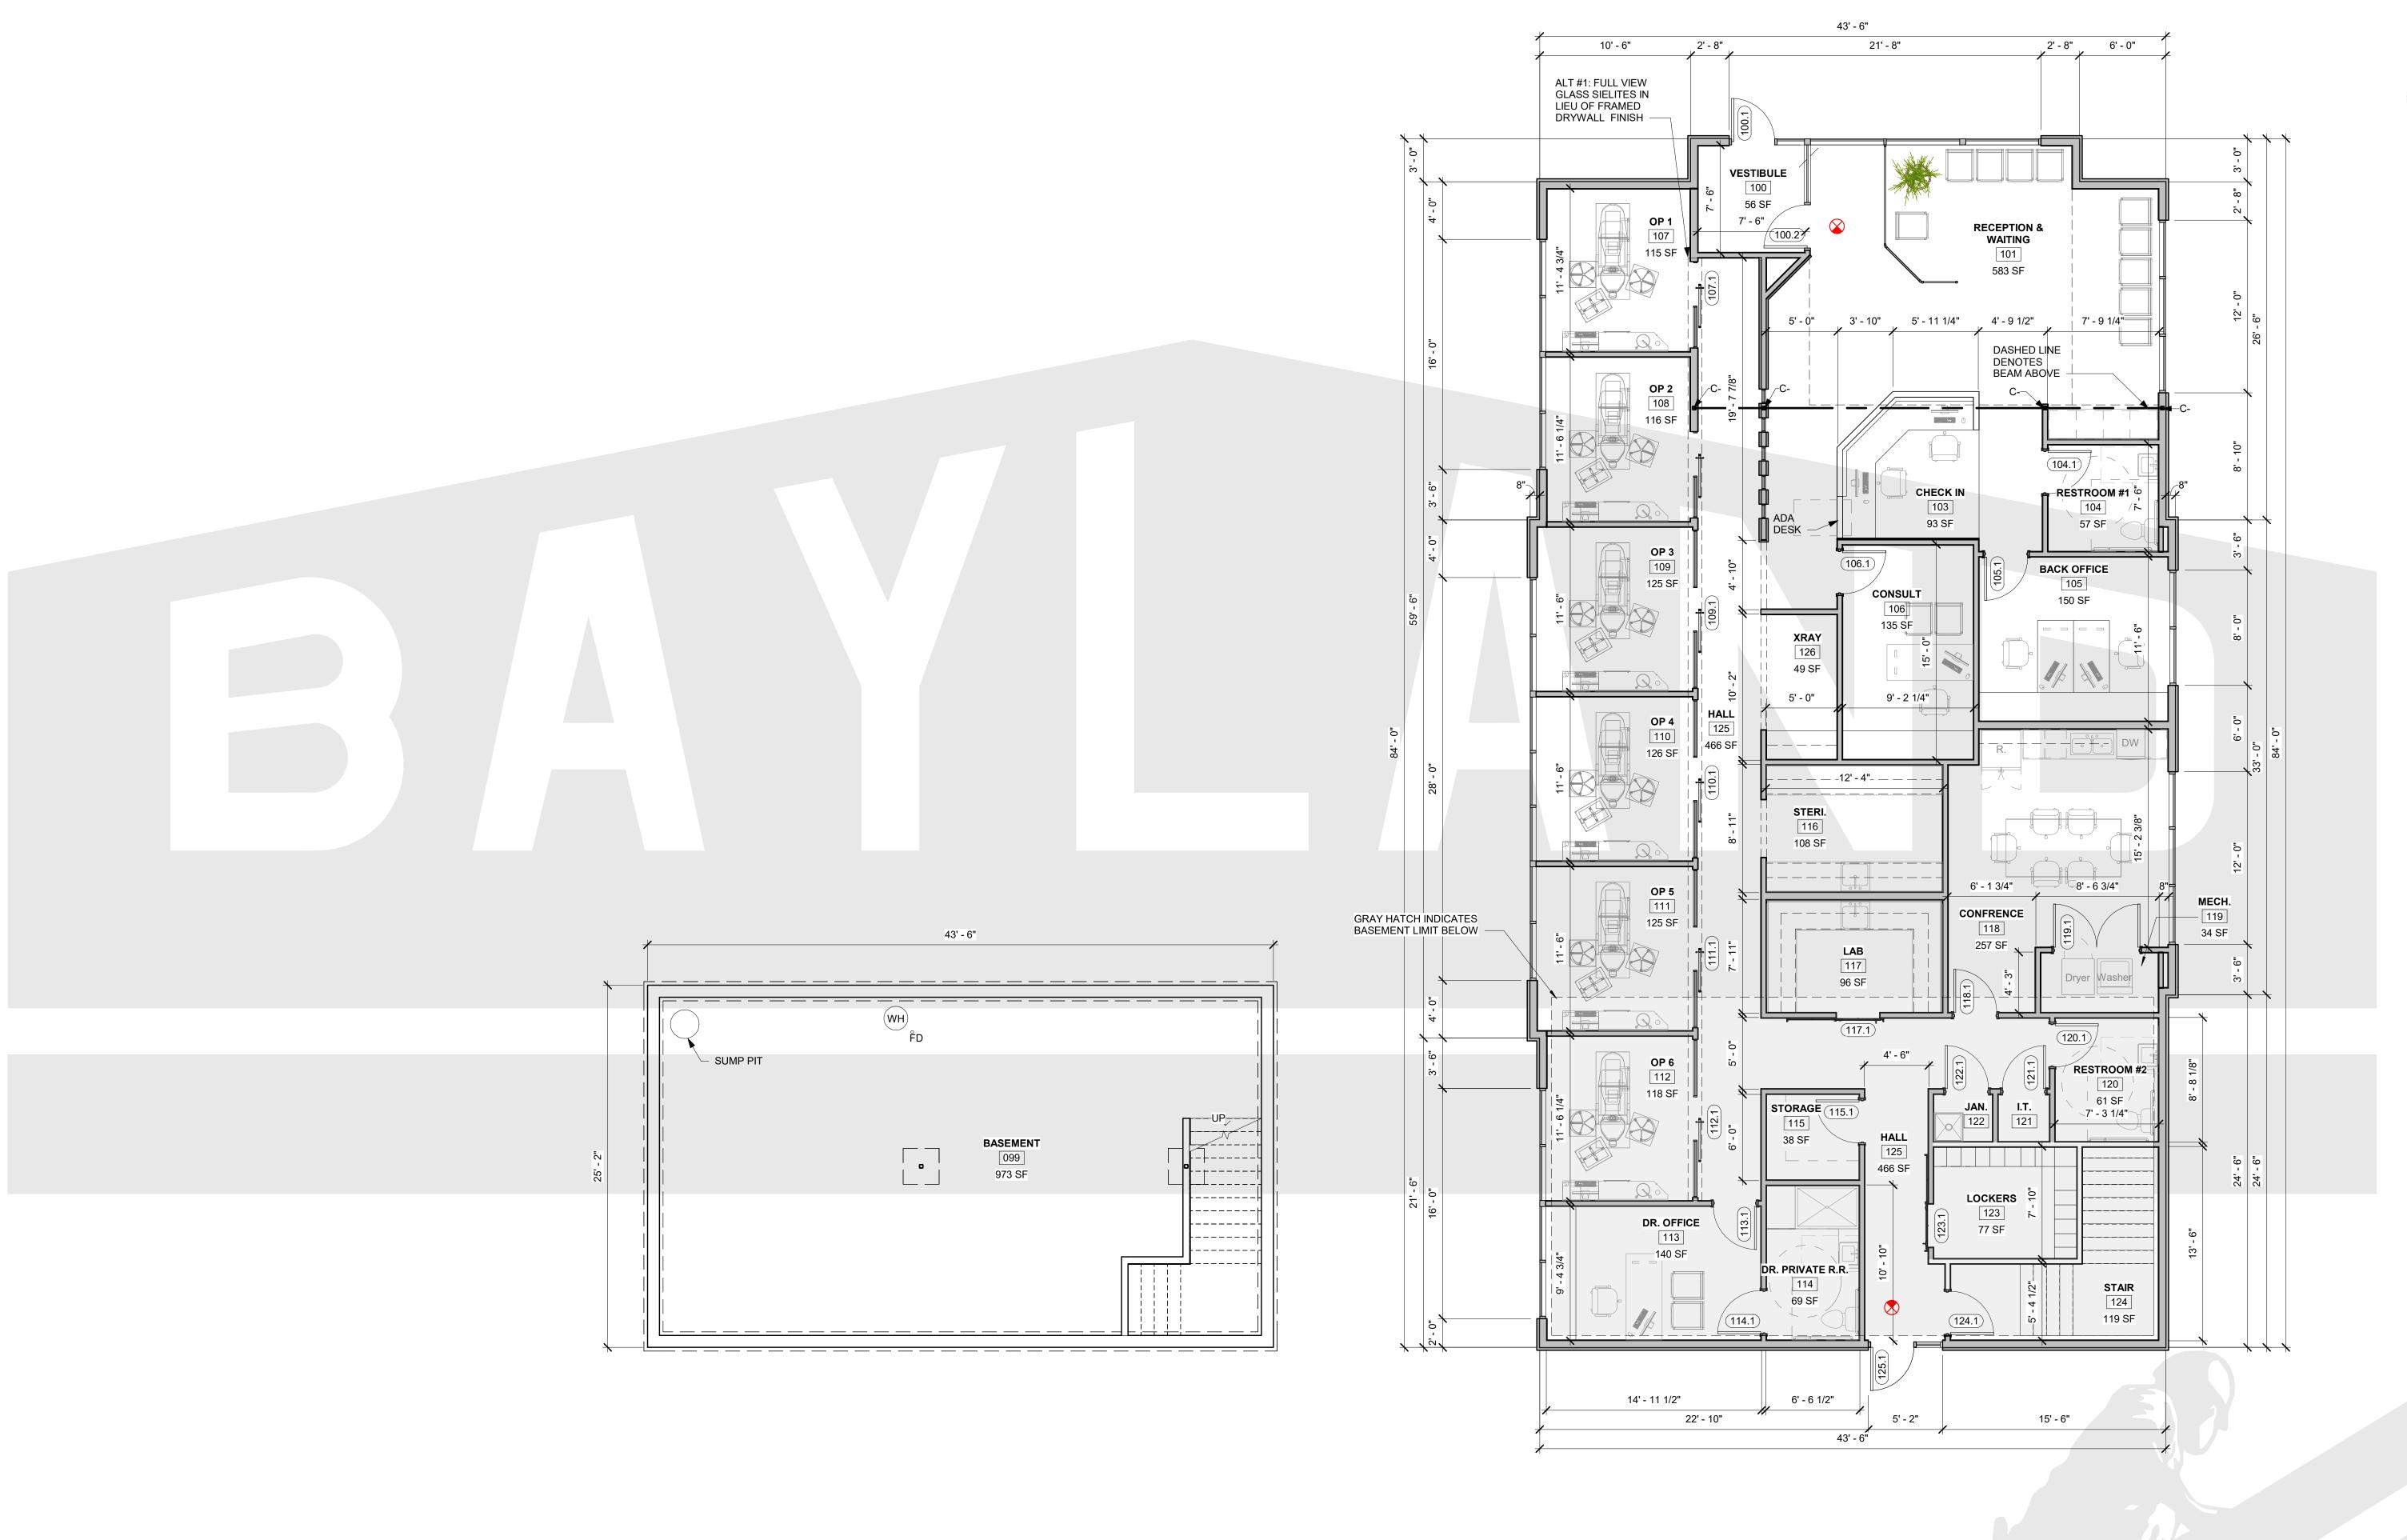

1 /A1.0 SCALE = 3/16" = 1'-0" OVERALL 1ST FLOOR PLAN

P.O. BOX 13571 GREEN BAY, WI 54307 (920) 498-9300 FAX (920) 498-3033 www.baylandbuildings.com DESIGN & BUILD GENERAL CONTRACTOR DENTIST OF: BROWN COUNTY \succ **BUILDING FOR:** AMIL WISCONSIN; L AR PROPOSED HOBART HOB, SCALE VERIFICATION THIS BAR MEASURES 1" ON ORIGINAL. ADJUST SCALE ACCORDINGLY NOTICE OF COPYRIGHT THESE PLANS ARE COPYRIGHTED AND ARE SUBJECT TO COPYRIGHT PROTECTION AS AN "ARCHITECTURAL WORK" UNDER SEC. 102 OF THE COPYRIGHT ACT, 17 U.S.O. AS AMENDED DECEMBER 1990 AND KNOWN AS ARCHITECTURAL WORKS COPYRIGHT PROTECTION ACT OF 1990. THE PROTECTION INCLUDES BUT IS NOT LIMITED TO THE OVERALL FORM AS WELL AS THE ARRANGEMENT AND COMPOSITION OF SPACES AND ELEMENTS OF THE DESIGN. UNDER SUCH PROTECTION, UNAUTHORIZED USE OF THESE PLANS, WORK OR BUILDING REPRESENTED, CAN LEGALLY RESULT IN THE CESSATION OF CONSTRUCTION OR BUILDINGS BEING SEIZED AND/OR MONETARY COMPENSATION TO BAYLAND BUILDINGS, INC. **JOB NUMBER:** 20-1698 PROJECT BRIAN PETERS (920) 362-7870 EXECUTIVE: DRAWN BY: CRP DATE: 11/16/2021 **REVISIONS:**

BAYLAND


BAYLAND BUILDINGS

ISSUED FOR: CHECKED DATE: BY: PRELIMINARY X BID SET DESIGN REVIEW CHECKSET CONSTRUCTION


OVERALL FLOOR PLAN


A1.0


3 /A2.0 SCALE = 1/8" = 1'-0" SOUTH ELEVATION

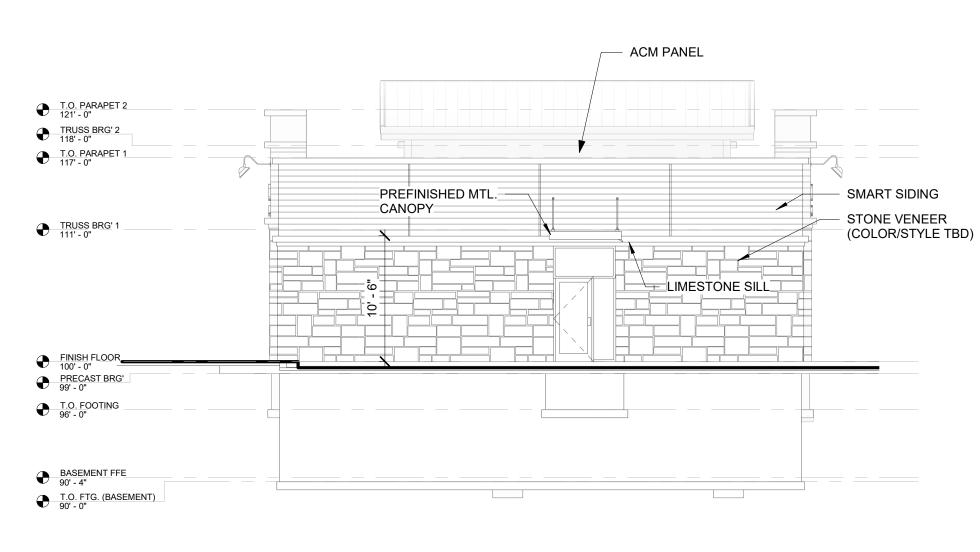



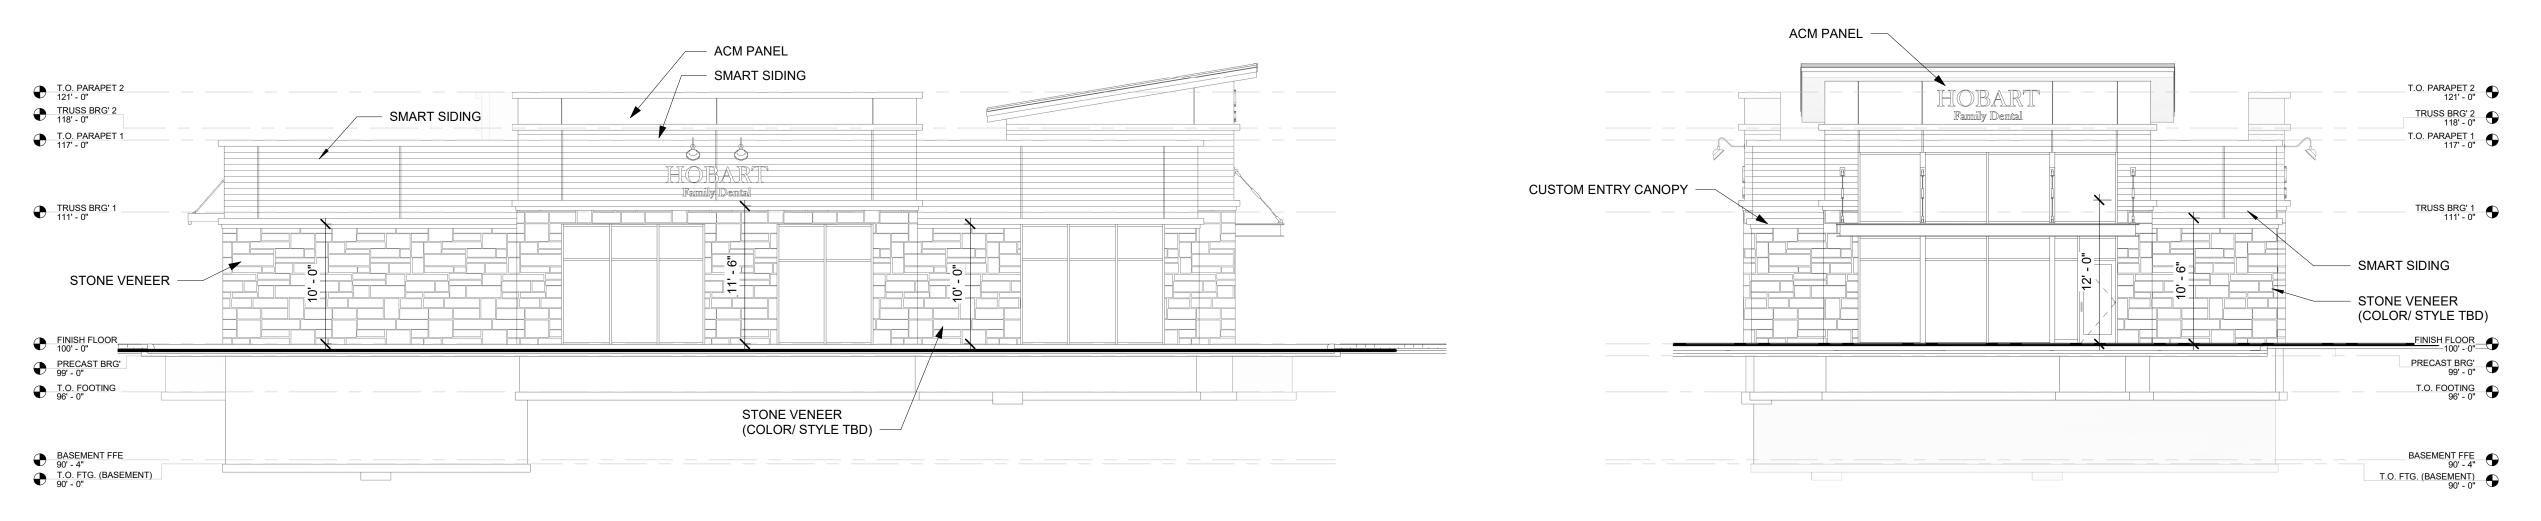

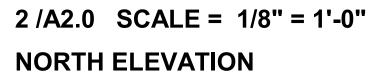

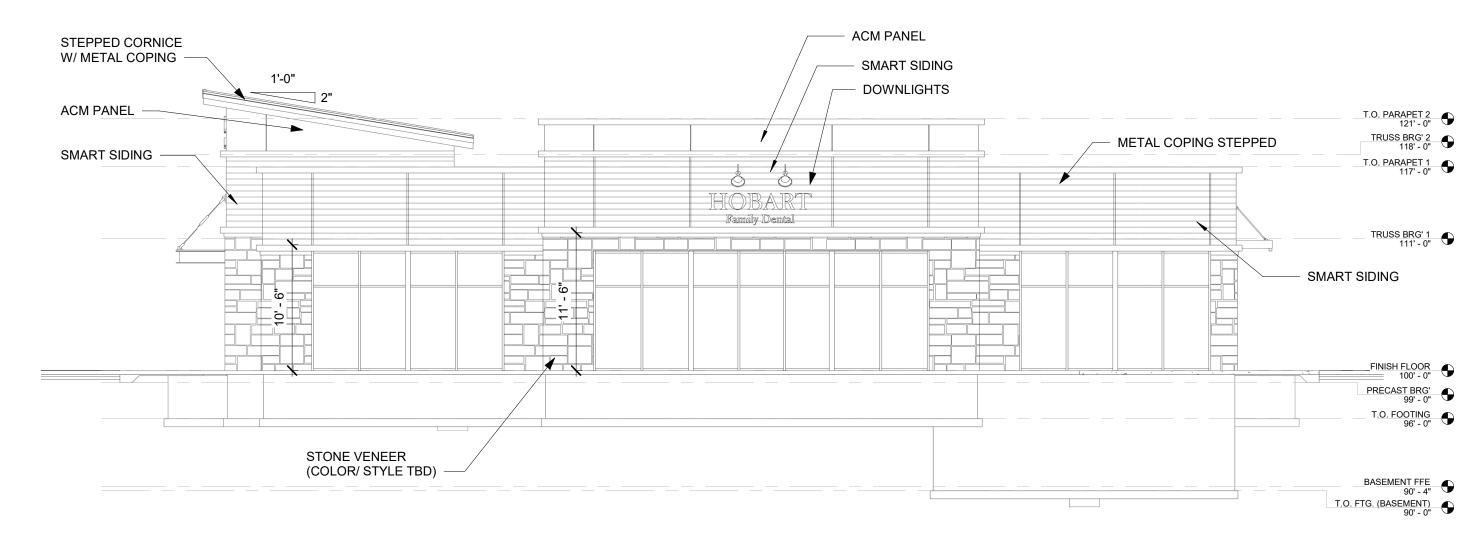







BAYLAND BUILDINGS


P.O. BOX 13571 GREEN BAY, WI 54307 (920) 498-9300 FAX (920) 498-3033 www.baylandbuildings.com

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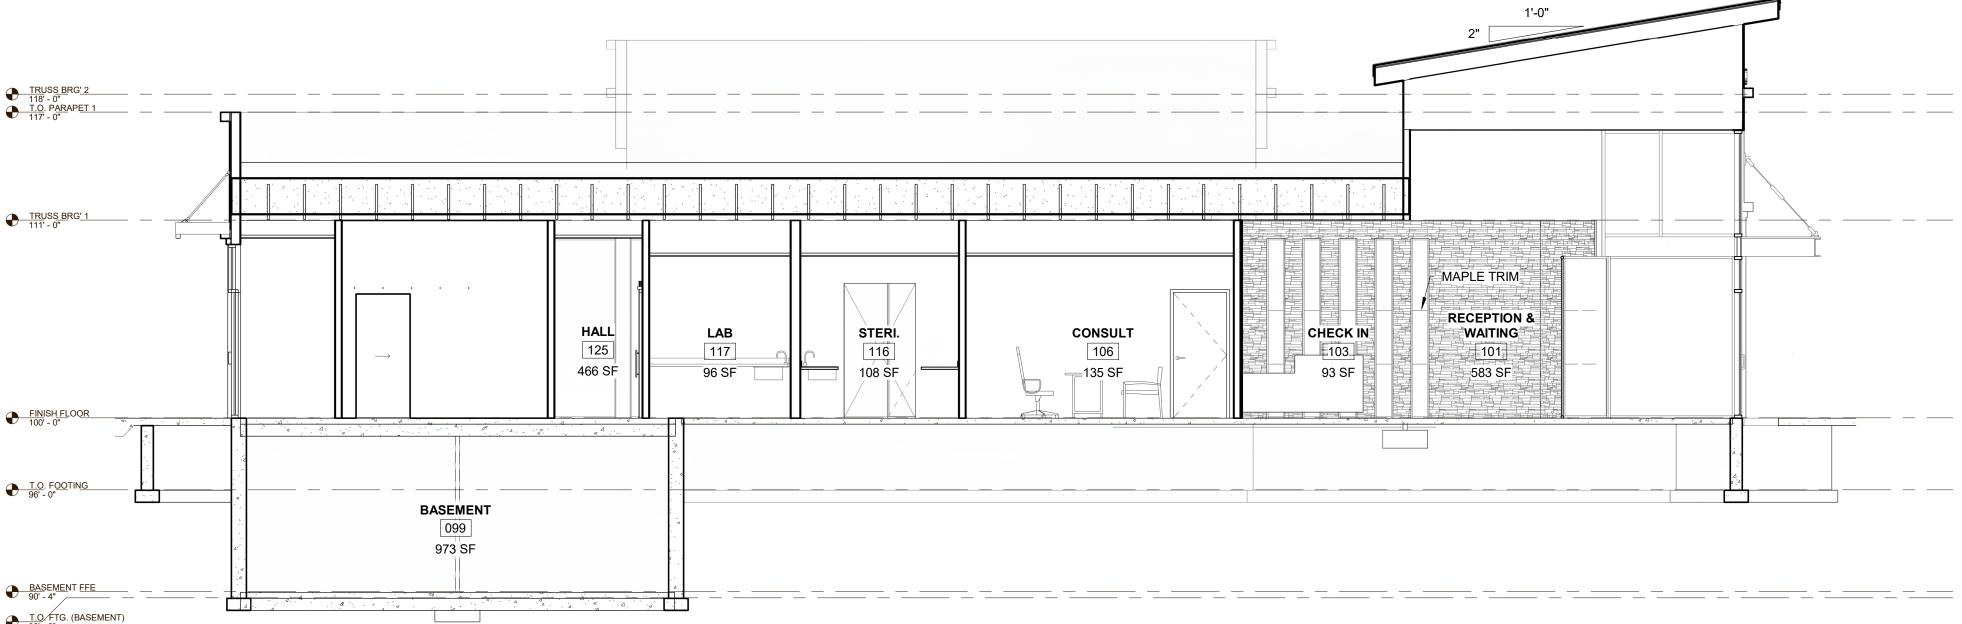


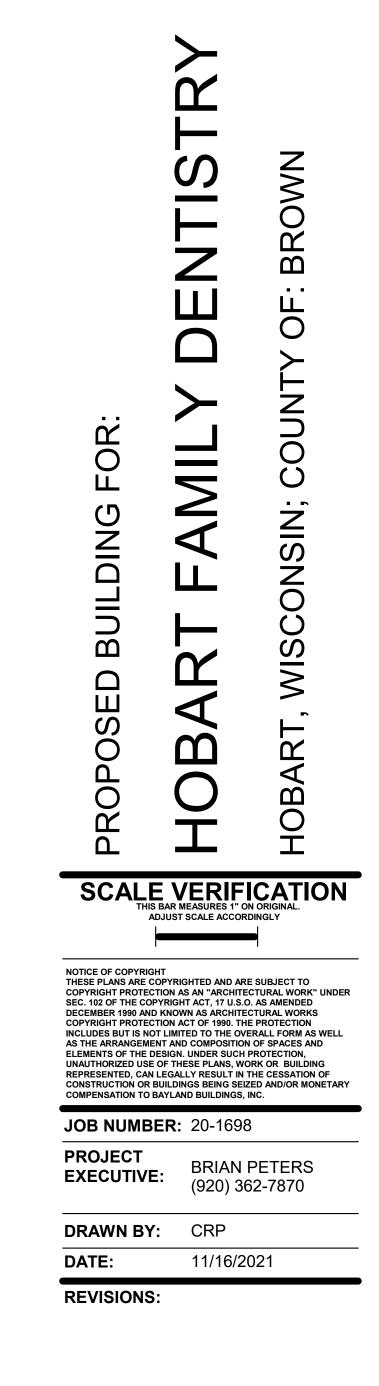


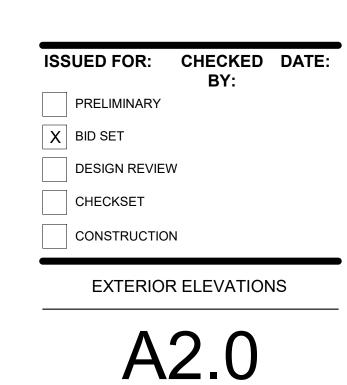
2 /A3.0 SCALE = 3/16" = 1'-0" **BUILDING SECTION 3**




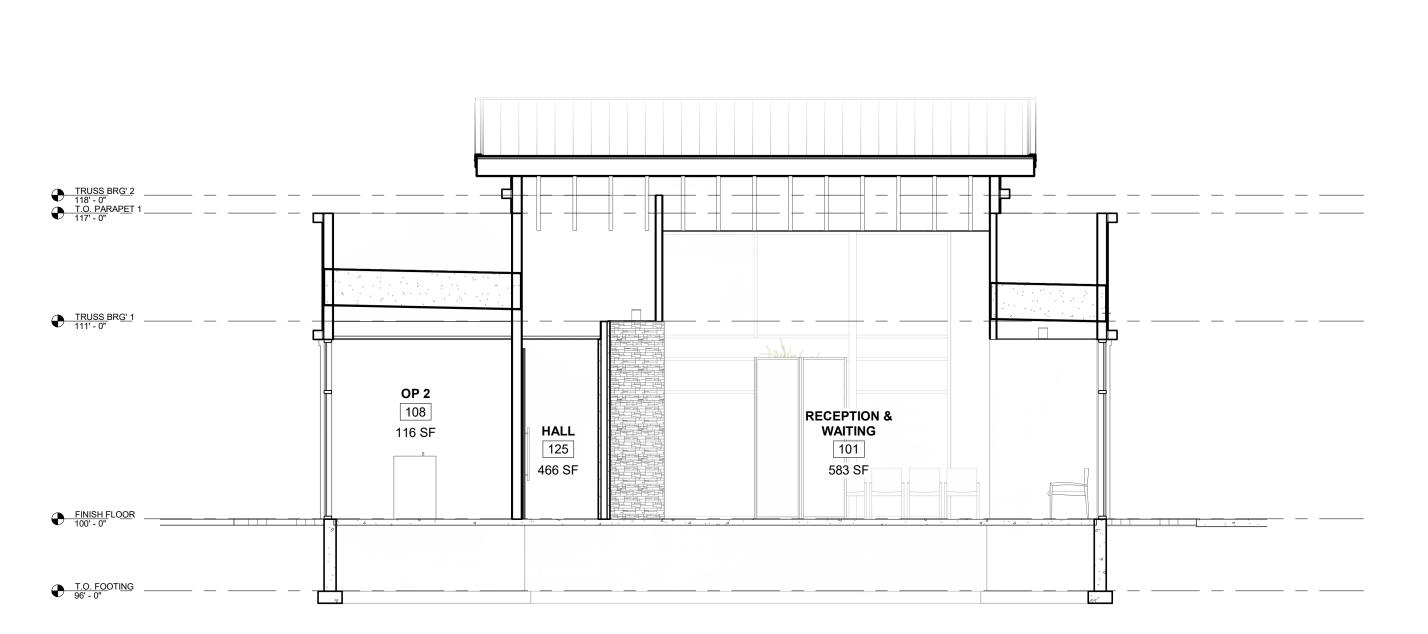



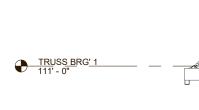

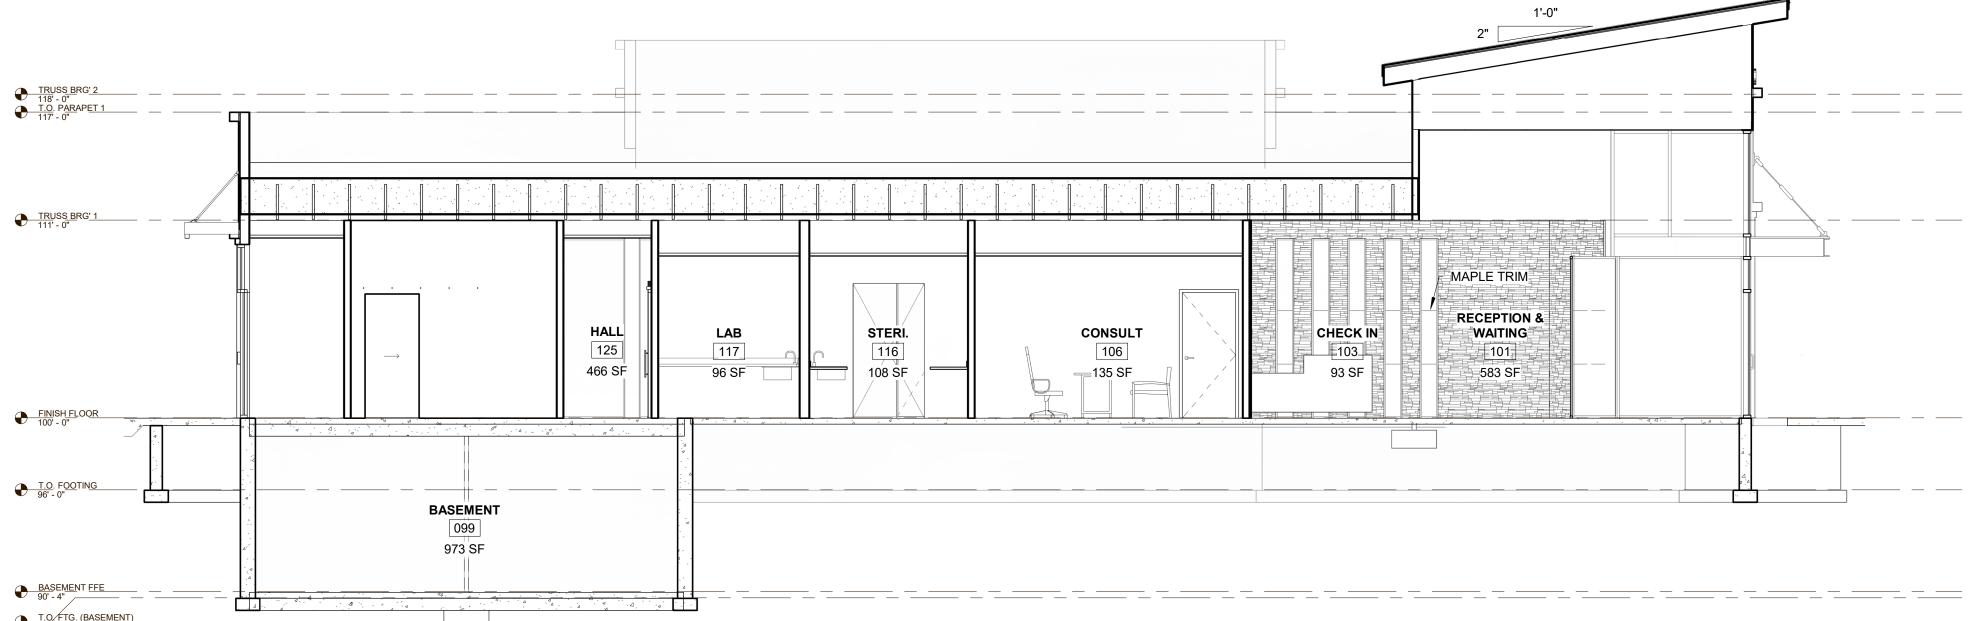

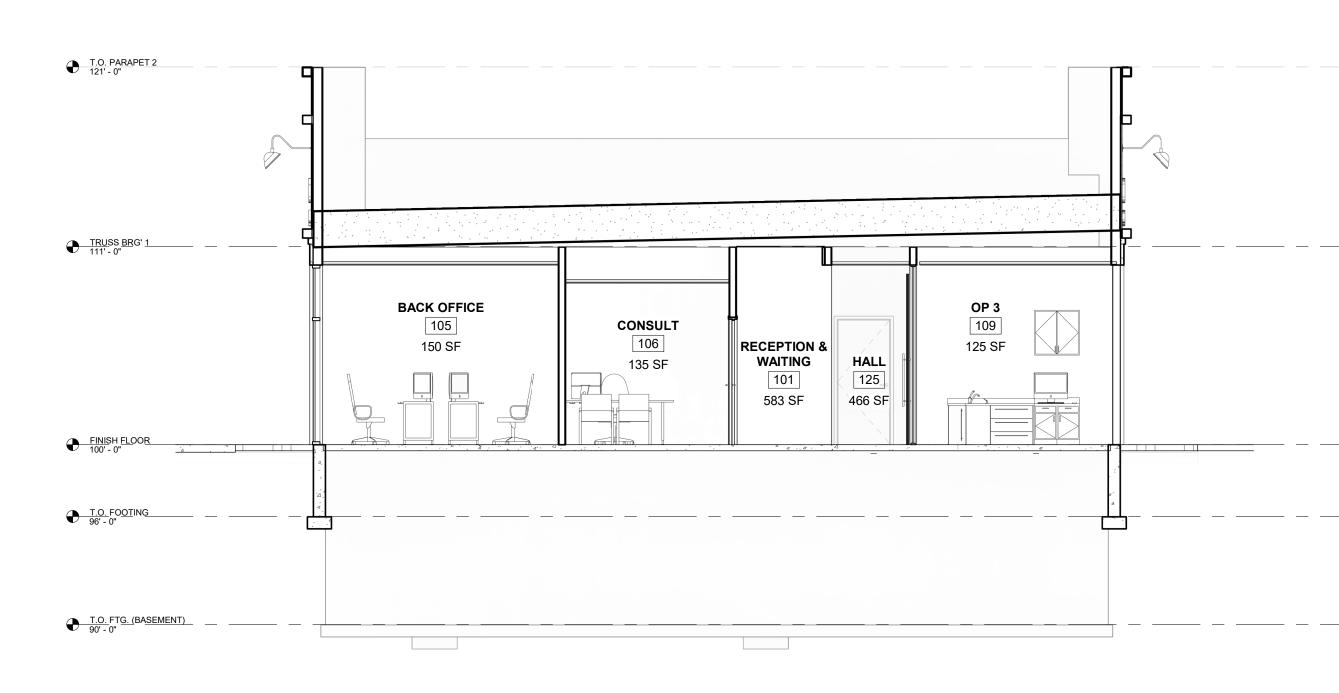

1 /A3.0 SCALE = 3/16" = 1'-0"

BUILDING SECTION 2

3 /A3.0 SCALE = 3/16" = 1'-0" **BUILDING SECTION 1**



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ISSUED FOR: CHECKED DATE: BY:
PRELIMINARY
X BID SET
DESIGN REVIEW
CHECKSET
CONSTRUCTION
BUILDING SECTIONS
A3.0